
HUNTER MILL ASSISTED LIVING

2347 HUNTER MILL ROAD

SPECIAL EXCEPTION PLAT (SE 2018-HM-024) Hunter Mill District Fairfax County, Virginia

> OCTOBER 17, 2018 **NOVEMBER 9, 2018** NOVEMBER 20, 2018 FEBRUARY 25, 2019 APRIL 19, 2019

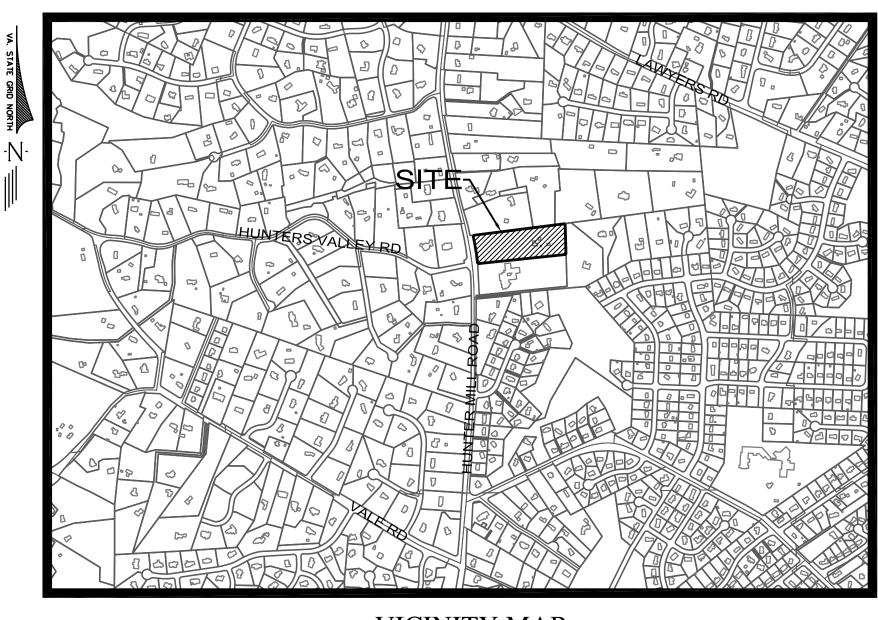

VICINITY MAP SCALE 1"=1000'

SHEET INDEX

- **COVER SHEET**
- NOTES & DETAILS
- CONCEPTUAL ELEVATIONS
- **EXISTING CONDITIONS**
- **EXISTING VEGETATION MAP**
- SPECIAL EXCEPTION PLAT
- TURNAROUND MOVEMENT EXHIBIT
- FRONTAGE IMPROVEMENTS
- LANDSCAPE PLAN
- LANDSCAPE COMPUTATIONS
- 10A SITE SECTION
- PRELIMINARY BMP ANALYSIS 11-12
- 13 PRELIMINARY SWM ANALYSIS
- ADEQUATE OUTFALL ANALYSIS
- SIGHT DISTANCE ANALYSIS

APPLICANT:

ORR **PARTNERS**

ORR-BSL HUNTER MILL, LLC

11180 SUNRISE VALLEY DRIVE SUITE 200 RESTON, VIRGINIA 20191 (703) 289-2100

ARCHITECT:



MOSELEY ARCHITECTS

8001 BRADDOCK ROAD SUITE 400 SPRINGFIELD, VIRGINIA 22151 (703) 426-9057


ATTORNEY:



WALSH COLUCCI LUBELEY & WALSH PC 2200 CLARENDON BLVD, SUITE 1300

ARLINGTON, VIRGINIA 22201-3359 (703) 528-4700 FAX: (703) 525-3197

CIVIL ENGINEER:

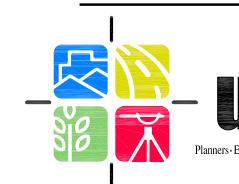






GENERAL NOTES

- 1. ALL REFERENCES HEREIN TO ZONING ORDINANCE REFER TO THE FAIRFAX COUNTY ZONING ORDINANCE.
- THE SUBJECT PROPERTY IS LOCATED IN THE HUNTER MILL DISTRICT, ON FAIRFAX COUNTY TAX MAP 37-2 ((1)) 26. ALL REFERENCES HEREIN TO PROPERTY, PARCEL OR SITE SHALL REFER TO THE SUBJECT PROPERTY.
- THE PROPERTY IS LOCATED WITHIN COMPREHENSIVE PLAN AREA II, VIENNA PLANNING DISTRICT, V4 PINEY BRANCH COMMUNITY PLANNING SECTOR.
- 4. THE PROPERTY IS CURRENTLY ZONED R-E. A SPECIAL EXCEPTION IS HEREBY REQUESTED TO ALLOW THE PROPOSED ASSISTED LIVING FACILITY, ADMINISTERED PER THE ZONING ORDINANCE AS A USE-6 MEDICAL CARE FACILITY UNDER SPECIAL EXCEPTION CATEGORY 3. AND AS PERMITTED IN THE R-E ZONING DISTRICT.
- THE BOUNDARY INFORMATION SHOWN IS BASED ON A FIELD RUN BOUNDARY SURVEY PERFORMED BY URBAN, LTD. IN AUGUST, 2018.
- THE TOPOGRAPHY SHOWN IS AT TWO FOOT CONTOUR INTERVAL, BASED ON A FIELD SURVEY PERFORMED BY URBAN, LTD. IN AUGUST, 2018 (NAD83, NGVD29).
- BASED UPON COUNTY MAPPING THERE IS MINOR FLOODPLAIN AND RESOURCE PROTECTION AREA LOCATED ON THE EASTERN PORTION OF THE SITE ALONG ANGELICO BRANCH. THERE ARE NO FEMA MAPPED FLOODPLAINS ON THE PROPERTY.
- AN EXISTING "FLOODPLAIN AND STORM DRAINAGE EASEMENT" AS LABELED ON DB 16501, PG 491, OVER 25 FEET WIDE IN VARIOUS LOCATIONS, EXISTS ON THE PROPERTY. THIS EASEMENT IS NOT A FEMA MAPPED FLOODPLAIN. THERE ARE NO OTHER EASEMENTS 25 FEET OR GREATER ON THE PROPERTY.
- AN ENVIRONMENTAL QUALITY CORRIDOR IS SHOWN WITH THIS APPLICATION.
- THERE ARE EXISTING CONSERVATION AND WATER QUALITY MANAGEMENT AREA EASEMENTS THAT EXIST ON THE PROPERTY AS RECORDED IN DB 16501, PG 491. THESE EASEMENTS ARE ASSOCIATED WITH A DISAPPROVED AND INACTIVE SITE PLAN (7438-SP-001). ANY PROPOSED WATER QUALITY BENEFIT PROVIDED BY THESE EASEMENTS IS NO LONGER VALID SINCE THE ASSOCIATED SITE PLAN WAS NEVER APPROVED. IT IS THE INTENTION TO VACATE AT LEAST A PORTION OF THESE EXISTING EASEMENTS AND RECORD NEW WATER QUALITY MANAGEMENT AREA EASEMENTS AT TIME OF FINAL RECORD PLAT AS MAY BE NECESSARY TO MEET SOME OR ALL OF THE WATER QUALITY REQUIREMENTS FOR THIS SPECIAL EXCEPTION APPLICATION AND THE FINAL SITE PLAN. THE VACATION OF EXISTING EASEMENTS AND THE CREATION OF NEW EASEMENTS WILL OCCUR WITH RECORDATION OF THE EASEMENT PLAT FOR THE PROPERTY SUBSEQUENT TO THE APPROVAL OF THIS SPECIAL EXCEPTION APPLICATION.
- 11. THERE ARE NO KNOWN GRAVE OR BURIAL SITES ON THIS PROPERTY.
- 12. THERE ARE NO KNOWN ENDANGERED OR THREATENED PLANT AND ANIMAL SPECIES IN THE PROJECT AREA.
- 13. ACCORDING TO THE COUNTYWIDE TRAILS PLAN, NO TRAILS ARE PROPOSED ON THE PROPERTY OR ALONG THE PROPERTY'S FRONTAGE. A MINOR PAVED TRAIL WITH PARALLEL NATURAL SURFACE OR STONE DUST TRAIL IS REQUIRED BY OTHERS ALONG THE WESTERN (OPPOSITE) SIDE OF HUNTER MILL ROAD, BUT IT SHOULD NOT BE A CONDITION OF DEVELOPMENT OF THIS PROPERTY.
- 14. THE PROPOSED DEVELOPMENT WILL NOT POSE ANY ADVERSE EFFECT ON ADJACENT OR NEIGHBORING PROPERTIES.
- 15. ALL STRUCTURES ON THE PROPERTY ARE TO BE REMOVED. PER FAIRFAX COUNTY RECORDS THE EXISTING PRINCIPAL STRUCTURE WAS CONSTRUCTED IN 1925, WITH AN ADDITION CONSTRUCTED IN 1957.
- THE PROJECT IS ANTICIPATED TO BE DEVELOPED IN A SINGLE PHASE.
- 17. SUBJECT TO MARKET CONDITIONS, IT IS ANTICIPATED THAT CONSTRUCTION OF THE PROPOSED DEVELOPMENT WILL COMMENCE AS SOON AS ALL NECESSARY COUNTY APPROVALS AND PERMITS ARE OBTAINED.
- 18. BASED UPON PRELIMINARY SITE INVESTIGATION, THERE ARE NO KNOWN HAZARDOUS OR TOXIC SUBSTANCES AS SET FORTH IN TITLE 40, CODE OF FEDERAL REGULATIONS PARTS 116.4, 302.4 AND 355; ALL HAZARDOUS WASTE AS SET FORTH IN COMMONWEALTH OF VIRGINIA DEPARTMENT OF WASTE MANAGEMENT REGULATIONS VR 672-10-1-VIRGINIA HAZARDOUS WASTE MANAGEMENT REGULATIONS: AND/OR PETROLEUM PRODUCTS AS DEFINED IN TITLE 40. CODE OF FEDERAL REGULATIONS PART 280: TO BE GENERATED, UTILIZED, STORED, TREATED AND/OR DISPOSED OF ON SITE.
- 19. WETLANDS SHOWN HEREIN WERE DELINEATED BY TNT ENVIRONMENTAL AS SHOWN IN THE "WETLAND DELINEATION" REPORT" FOR THE "PROPOSED ORR ASSISTED LIVING FACILITY" DATED MAY 17, 2017. JURISDICTIONAL DETERMINATION BY ACOE HAS NOT YET BEEN PERFORMED AS OF THE DATE OF THIS APPLICATION.
- 20. THE PROPOSED DEVELOPMENT WILL CONFORM TO THE PROVISIONS OF ALL APPLICABLE ORDINANCES. REGULATIONS AND ADOPTED STANDARDS EXCEPT AS MAY BE SPECIFIED OTHERWISE.
- 21. PUBLIC WATER SHALL BE PROVIDED BY EXTENSION OF EXISTING SERVICE ON THE PROPERTY. SANITARY SEWER WILL BE PROVIDED BY INSTALLATION OF A PROPOSED PRIVATELY OWNED AND MAINTAINED INDIVIDUAL ONSITE SEWAGE DISPOSAL SYSTEM. SOLID WASTE REMOVAL SHALL BE PROVIDED BY PRIVATE CONTRACTORS.
- 22. ALL PROPOSED UTILITIES INTERNAL TO THE SITE SERVING THE PROPOSED BUILDING WILL BE PLACED UNDERGROUND.
- 23. PARKING WILL BE PROVIDED IN ACCORDANCE WITH THE PROVISIONS OF ARTICLE 11 OF THE ZONING ORDINANCE.
- 24. THE BUILDING FOOTPRINT SHOWN IS PRELIMINARY AND APPROXIMATE. THE SIZE AND CONFIGURATION MAY BE REVISED PROVIDED THAT THE MINIMUM SETBACKS ARE NOT DIMINISHED.
- 25. MINOR MODIFICATIONS IN ACCORDANCE WITH THE ZONING ORDINANCE INCLUDING THE LIMITS OF CLEARING AND GRADING, LANDSCAPED OPEN SPACE AND LOCATIONS OF SIDEWALKS, UTILITIES, DRAINFIELD AND STORMWATER MANAGEMENT FACILITIES MAY OCCUR WITH FINAL SITE ENGINEERING WITHOUT REQUIRING AN AMENDMENT TO THIS PLAT.
- 26. LANDSCAPING WILL BE PROVIDED IN ACCORDANCE WITH THE APPLICABLE PROVISIONS OF ARTICLE 13 AND THIS PLAT.
- 27. STORMWATER MANAGEMENT FACILITIES WILL CONFORM TO ALL FAIRFAX COUNTY REQUIREMENTS. WATER QUANTITY, WATER QUALITY AND OUTFALL REQUIREMENTS WILL BE MET WITH A COMBINATION OF UNDERGROUND FACILITIES, MANUFACTURED DEVICES, PRESERVATION OF OPEN SPACE AND/OR THE USE OF ANY OTHER DEVICE(S) THAT ARE APPROVED FOR USE IN FAIRFAX COUNTY TO MEET WATER QUALITY OR WATER QUANTITY REQUIREMENTS. THE STORMWATER FACILITIES SHOWN ON THIS PLAT ARE PRELIMINARY AND SUBJECT TO CHANGE AT TIME OF FINAL ENGINEERING IF APPROVED BY MINOR MODIFICATION IN ACCORDANCE WITH THE ZONING ORDINANCE WITHOUT REQUIRING AN AMENDMENT TO THIS PLAT.
- 28. ANY SIGNS SHALL BE IN ACCORDANCE WITH THE PROVISIONS OF ARTICLE 12 OF THE ZONING ORDINANCE.
- 29. FIRE LANES WILL BE INDICATED PER FAIRFAX COUNTY REQUIREMENTS.
- 30. ANY PROPOSED OFF-SITE IMPROVEMENTS SHALL BE SUBJECT TO RECEIPT OF PERMISSION FROM THE OFF-SITE PROPERTY OWNER(S).

SOILS MAP SCALE 1"=500'

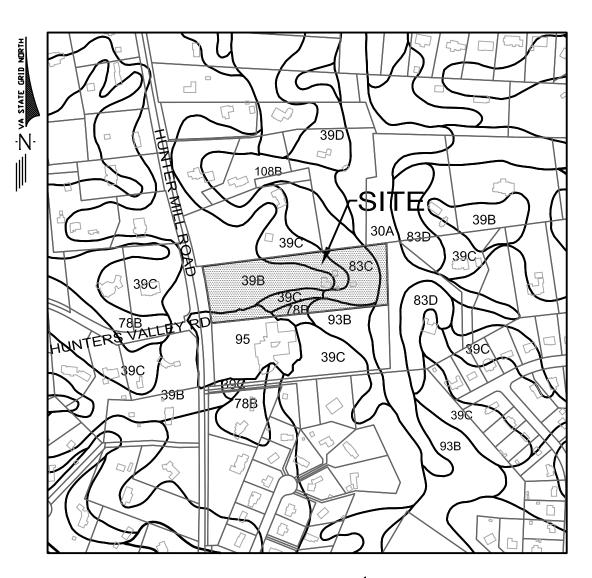

SOILS RATINGS


SOIL I.D. NUMBER	SERIES NAME	SUBSURFACE DRAINAGE	FOUNDATION SUPPORT	SLOPE STABILITY	ERODIBILITY	DRAINFIELD SUITABILITY	GEOTECHNICAL ² REPORT REQD.
39B	GLENELG SILT LOAM	GOOD	GOOD	HIGH	HIGH	GOOD	NO
39C	GLENELG SILT LOAM	GOOD	GOOD	HIGH	HIGH	GOOD	NO
78B	MEADOWVILLE LOAM	MARGINAL-W	FAIR-W,B	MODHIGH	MEDIUM	MARGINAL-W	NO
83C	ORANGE SILT LOAM VERY STONY	POOR-P,C,R,S	POOR-P,C,B	POOR	HIGH	POOR-P,C,S,R	YES
93B	SUMERDUCK LOAM	POOR-W	MARGINAL-W,B	MODHIGH	MEDIUM	POOR-W,S	NO

SOILS NOTES:


1. SOILS INFORMATION AND MAPPING PROVIDED BY THE OFFICIAL 2018 FAIRFAX COUNTY SOIL MAPS. 2. GEOTECHNICAL REPORT REQUIRED AT TIME OF SITE PLAN.

ANGLE OF BULK PLANE FRONT YARD

N.T.S.

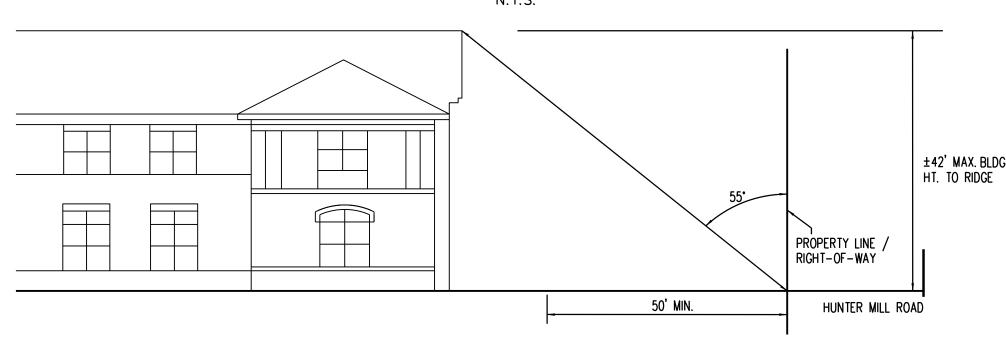

ANGLE OF BULK PLANE SIDE/REAR YARD

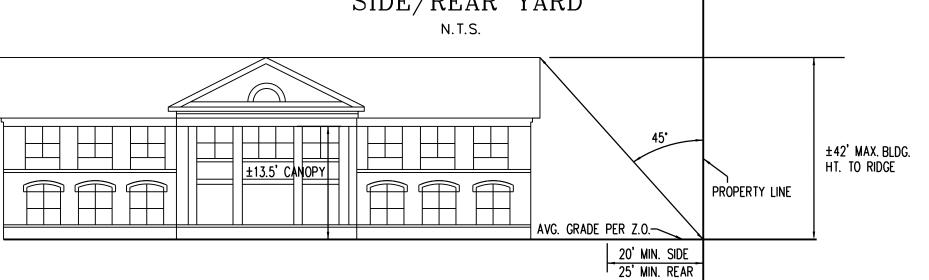

REQUESTED WAIVERS/MODIFICATIONS

1. MODIFICATION OF THE BARRIER REQUIREMENT OF Z.O 13-304 IS REQUESTED FOR THE EASTERN PROPERTY LINE AND A PORTION OF THE NORTHERN PROPERTY LINE WHERE DUE TO THE TOPOGRAPHY, THE BARRIER WILL NOT BE EFFECTIVE.

ZONING TABULATIONS

GROSS SITE AREA..... 291,224 SQ. FT. or 6.69 AC. EXISTING ZONING...... EXISTING OPEN SPACE.... REQUIRED OPEN SPACE.... .. NONE REQUIRED PROPOSED OPEN SPACE (INFORMATION ONLY)..... 5.0 AC (75%) OPEN SPACE MAY VARY AT FINAL SITE PLAI MAXIMUM BUILDING HEIGHT PERMITTED..... PROPOSED BUILDING HEIGHT... .. 35 FT. MAX (AVG. GRADE TO MID-ROOF AS PER Z.O.) MINIMUM REQUIRED YARDS: FRONT YARD... . 55° ANGLE BULK PLANE, NOT LESS THAN 50 FT. SIDE YARD.. .. 45° ANGLE BULK PLANE, NOT LESS THAN 20 FT. REAR YARD. .. 45° ANGLE BULK PLANE, NOT LESS THAN 25 FT. MAXIMUM FLOOR AREA RATIO.....

PROPOSED GROSS FLOOR AREA... ... 43.680 SQ. FT.

PROPOSED FLOOR AREA RATIO... .. 43,680 / 291,224 SQ. FT. = 0.149

ZONING REQUIREMENTS PER SECTION 9-308

FOR MEDICAL CARE FACILITIES: MINIMUM LOT SIZE REQUIRED...

MINIMUM LOT WIDTH REQUIRED...

ACTUAL LOT SIZE.....

ACTUAL LOT WIDTH.....

. 45' TO ANY STREET LINE BUILDING SETBACKS REQUIRED. 100' TO ANY LOT LINE

.. >45' TO STREET LINE BUILDING SETBACKS PROVIDED.

PARCEL FRONTS ON AN EXISTING MINOR ARTERIAL TYPE "B" STREET

>100' TO ANY LOT LINE

...6.69 ACRES

PARKING TABULATIONS

PARKING SPACES REQUIRED.. 59 SPACES (1 SPACE PER 3 RESIDENTS. (86 BEDS / 3 + 30 EMPLOYEES) PLUS 1 SPACE PER EMPLOYEE)

60 SPACES MINIMUM PARKING SPACES PROVIDED..

(54 STANDARD + 1 VAN + 5 ACCESSIBLE)

CHAPTER 527/870 DETERMINATION APPROVAL:

From: Guthrie, Michelle < Michelle.Guthrie@Fairfaxcounty.gov >

Sent: Friday, September 28, 2018 1:10 PM To: Kevin D. Sitzman < kds@goroveslade.com >

Cc: Steven Dauterman < srd@goroveslade.com; Chad A. Baird < cab@goroveslade.com; Abrahamson, Kris <<u>Kris.Abrahamson@fairfaxcounty.gov</u>>; Fuller, Gregory <<u>Gregory.Fuller@fairfaxcounty.gov</u>>; Garcia, Michael W < <u>Michael.Garcia3@fairfaxcounty.gov</u>>; Hermann, Jeffrey C. < <u>Jeffrey.Hermann@fairfaxcounty.gov</u>>; lannetta, Elizabeth A. <Elizabeth.lannetta@fairfaxcounty.gov>; Krasner, Brent M. <Brent.Krasner@fairfaxcounty.gov>; Lewis, Catherine E. <<u>Catherine.Lewis@fairfaxcounty.gov</u>>; Mayland, William <<u>William.Mayland@Fairfaxcounty.gov</u>>; O'Donnell, William <William.O'Donnell@fairfaxcounty.gov>; Pemberton, Debbie <<u>Debbie.Pemberton@Fairfaxcounty.gov</u>>; Wright, Suzanne L. <suzanne.wright@fairfaxcounty.gov>

Subject: Ch 870 Determination / Hunter Mill Road Assisted Living

The proposed application to replace a single family dwelling with an 85 bed assisted living facility on 2347 Hunter Mill Rd (tax map 37-2((1))0026) does not require a Ch 870 TIA.

Additional review by Fairfax County Transportation (FCDOT) will occur once Zoning distributes the case to county agencies. If additional transportation issues need to be addressed/discussed, Transportation and Zoning will coordinate and contact you.

Please include this email correspondence with your application submittal. I am including Zoning staff for notification purposes.

Thanks and have a good day!

Michelle Guthrie Fairfax County Transportation

From: Kevin D. Sitzman [mailto:kds@goroveslade.com] Sent: Tuesday, September 25, 2018 11:39 AM To: Guthrie, Michelle < Michelle. Guthrie@Fairfaxcounty.gov> Cc: Steven Dauterman < srd@goroveslade.com >; Chad A. Baird < cab@goroveslade.com > Subject: Hunter Mill Road Assisted Living

Michelle,

I have attached our Chapter 527/870 Determination Memo for the Hunter Mill Assisted Living site. The proposal would replace the current single-family home with an 85-bed facility. As the attached memo shows, the use would generate about 221 trips per day, well below the 5,000 trips per day threshold to require a Chapter 870 TIA.

Please let us know if Fairfax County concurs with our conclusion in the attached memo.


Kevin D. Sitzman, P.E.

Project Manager

Gorove/Slade Associates, Inc. Transportation, Traffic, and Parking p: 571-248-0992 | d: 571-261-9718 | c: 571-318-1285 | f: 703-787-9905 15125 Washington Street, Suite 212 | Haymarket, VA 20169 kevin.sitzman@goroveslade.com | www.goroveslade.com



7712 Little River Turnpike Annandale, Virginia 22003 TEL 703.642.8080 FAX 703.642.8251 www.urban-ltd.com

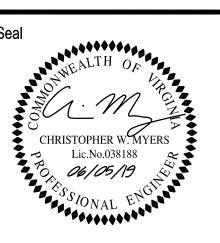

ORR PARTNERS 11180 SUNRISE VALLEY DR RESTON, VIRGINIA 20191 (703) 289-2100

Revision / Issue No. Description 10/19/2018 1ST SUBMISSION 1ST SUBMISSION (REV) 11/09/2018 1ST SUBMISSION (REV) 11/20/2018 2ND SUBMISSION 02/25/2019 3RD SUBMISSION 04/19/2019 4TH SUBMISSION

Project Name

ASSISTED LIVING SPECIAL EXCEPTION PLAT

HUNTER MILL

Hunter Mill District Fairfax County, Virginia

Checked By

Project No. MISC-2381

Date JUNE 5, 2019

Drawing Title

NOTES AND **DETAILS**

Scale: AS SHOWN

Drawing Number

Sheet 2 of 15














CELLAR DETAIL

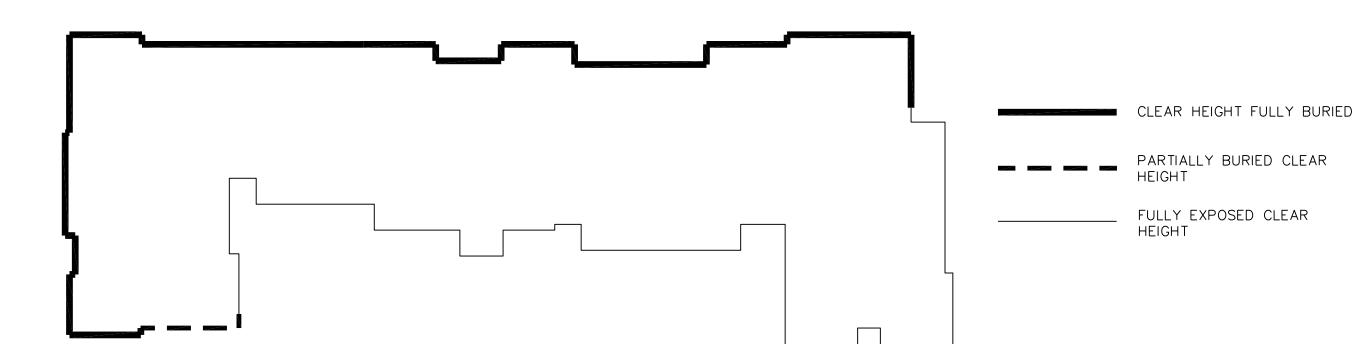

= 355.80' = 361.50 = 5.7' LOWER LEVEL FLOOR ELEV. AVG. GRADE ELEV. AVG. BURIED DEPTH CLEAR HEIGHT LOWER LEVEL % CLEAR HEIGHT BURIED = 11.0'= 51.8% > 50%

NOTE: DUE TO CLEAR HEIGHT BEING BURIED MORE THAN 50%, LOWER LEVEL SHALL BE CONSIDERED A CELLAR.

EXHIBIT AND COMPUTATIONS ARE ILLUSTRATIVE TO DEMONSTRATE THAT LOWER LEVEL MAY BE CONSIDERED A CELLAR PER DEFINITION OF THE ZONING ORDINANCE. ALL GRADING, BUILDING ELEVATIONS AND COMPUTATIONS SHOWN HEREON ARE APPROXIMATE AND SUBJECT TO CHANGE WITH FINAL ENGINEERING.

7712 Little River Turnpike Annandale, Virginia 22003 TEL 703.642.8080 FAX 703.642.8251 www.urban-ltd.com

Lic.No.038188

Client

ORR PARTNERS 11180 SUNRISE VALLEY DR RESTON, VIRGINIA 20191 (703) 289-2100

Rev	ision / Issue	
No.	Description	Date
1.	1ST SUBMISSION	10/19/2018
2.	1ST SUBMISSION (REV)	11/09/2018
3.	1ST SUBMISSION (REV)	11/20/2018
4.	2ND SUBMISSION	02/25/2019
5.	3RD SUBMISSION	04/19/2019
6.	4TH SUBMISSION	06/05/2019

Project Name

HUNTER MILL ASSISTED LIVING

SPECIAL EXCEPTION PLAT

Hunter Mill District Fairfax County, Virginia

Checked By CM Project No. MISC-2381

Date JUNE 5, 2019

Drawing Title

NOTES AND DETAILS

Scale: AS SHOWN

Drawing Number


Sheet 3 of 15

FOR ILLUSTRATIVE PURPOSES ONLY.

NOTE: CONCEPTUAL ELEVATIONS SHOWN FOR ILLUSTRATIVE PURPOSES ONLY. ILLUSTRATIONS HEREIN SHOW GENERAL INTENT OF BUILDING CHARACTER. DIMENSIONS, BUILDING MATERIALS AND COLORS MAY VARY AT TIME OF FINAL DESIGN.



WEST ELEVATION

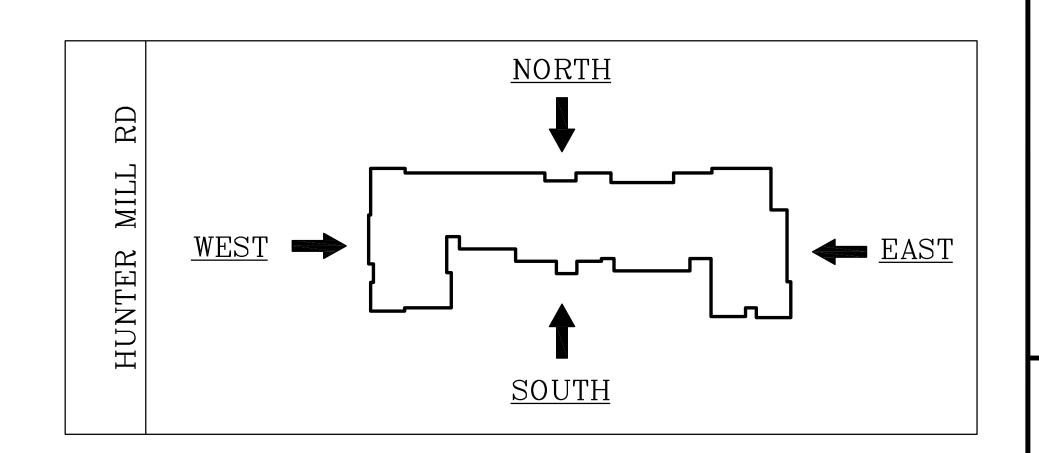



ORR PARTNERS 11180 SUNRISE VALLEY DR RESTON, VIRGINIA 20191 (703) 289-2100

urban

7712 Little River Turnpike Annandale, Virginia 22003 TEL 703.642.8080 FAX 703.642.8251 www.urban-ltd.com

Lic.No.038188

Revision / Issue 1. 1ST SUBMISSION 10/19/2018

2ND SUBMISSION 3RD SUBMISSION 04/19/2019 4TH SUBMISSION

Project Name

HUNTER MILL ASSISTED LIVING

SPECIAL EXCEPTION PLAT

Hunter Mill District

Fairfax County, Virginia Checked By CM

Project No. MISC-2381

Date JUNE 5, 2019

Drawing Title

CONCEPTUAL **ELEVATIONS**

Scale: AS SHOWN

Drawing Number

Sheet 4 of 15

SOUTH ELEVATION

MOSELEYARCHITECTS
8001 BRADDOCK ROAD, SUITE 400, SPRINGFIELD, VA 22151
PHONE (703) 426-9057 FAX (703) 426-9280
MOSELEYARCHITECTS.COM

HUNTER MILL ROAD, VIRGINIA

FEBRUARY 6, 2019



EAST ELEVATION





NORTH ELEVATION


580038

FEBRUARY 6, 2019


HUNTER MILL ROAD, VIRGINIA

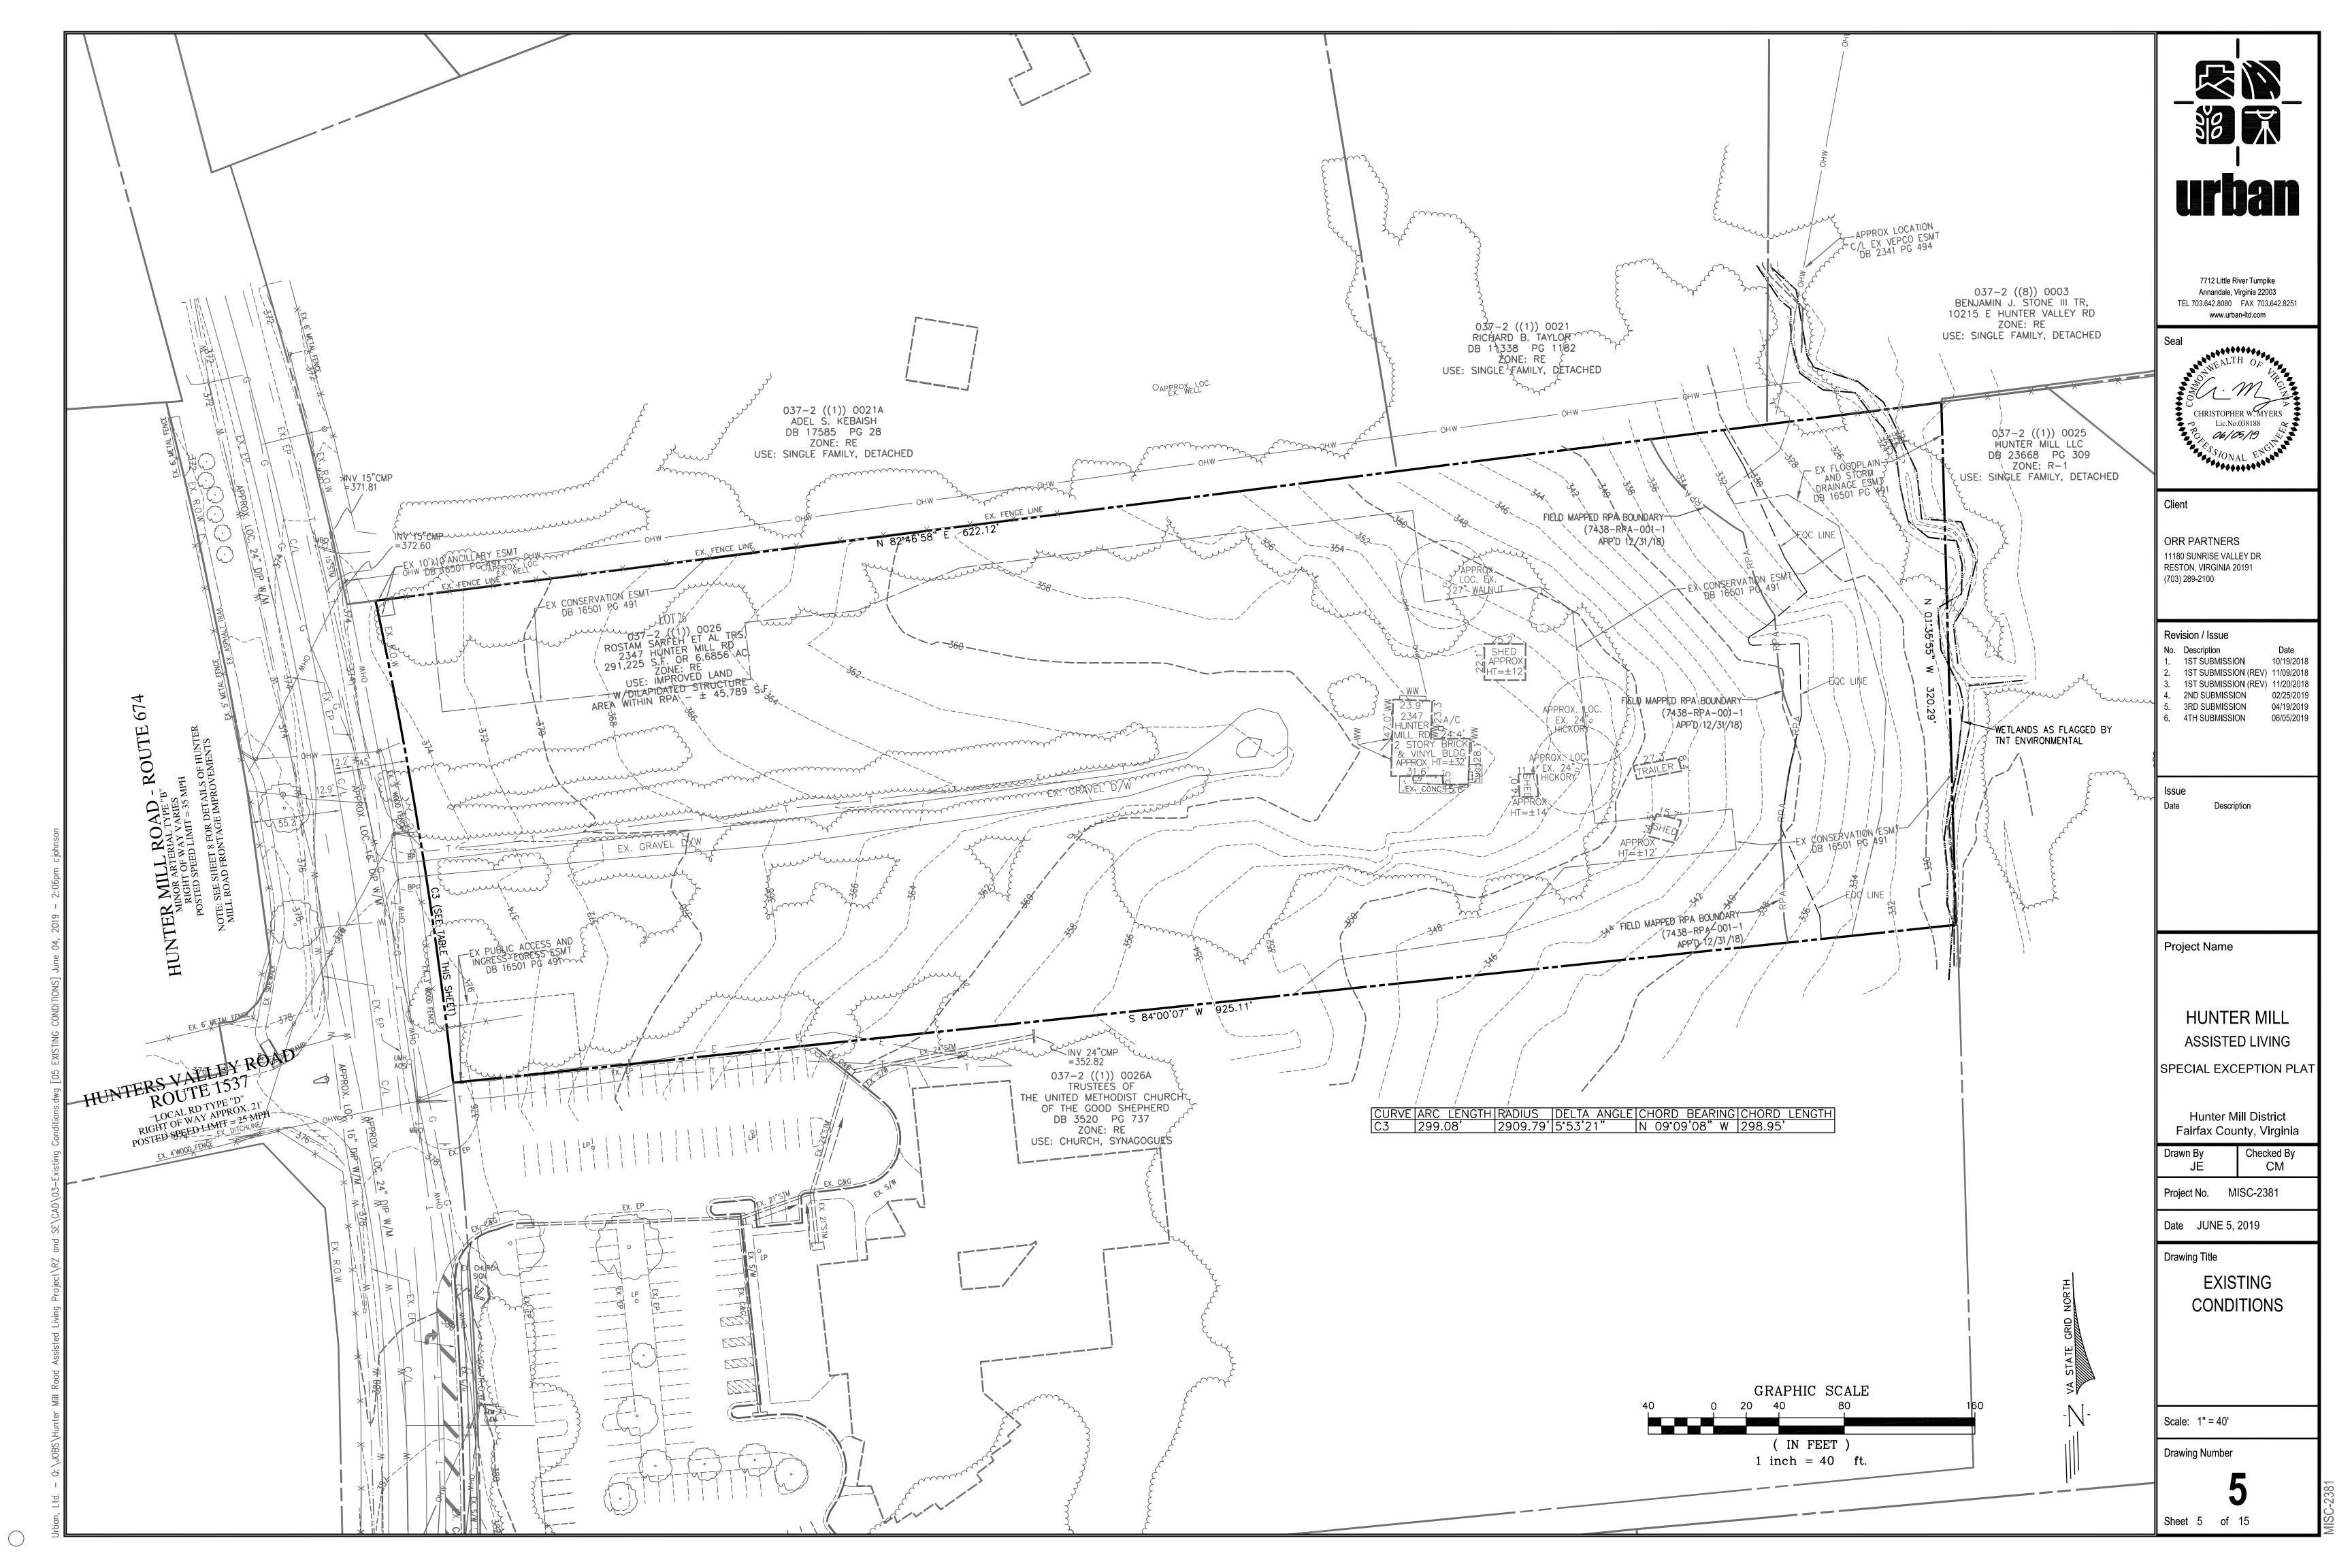

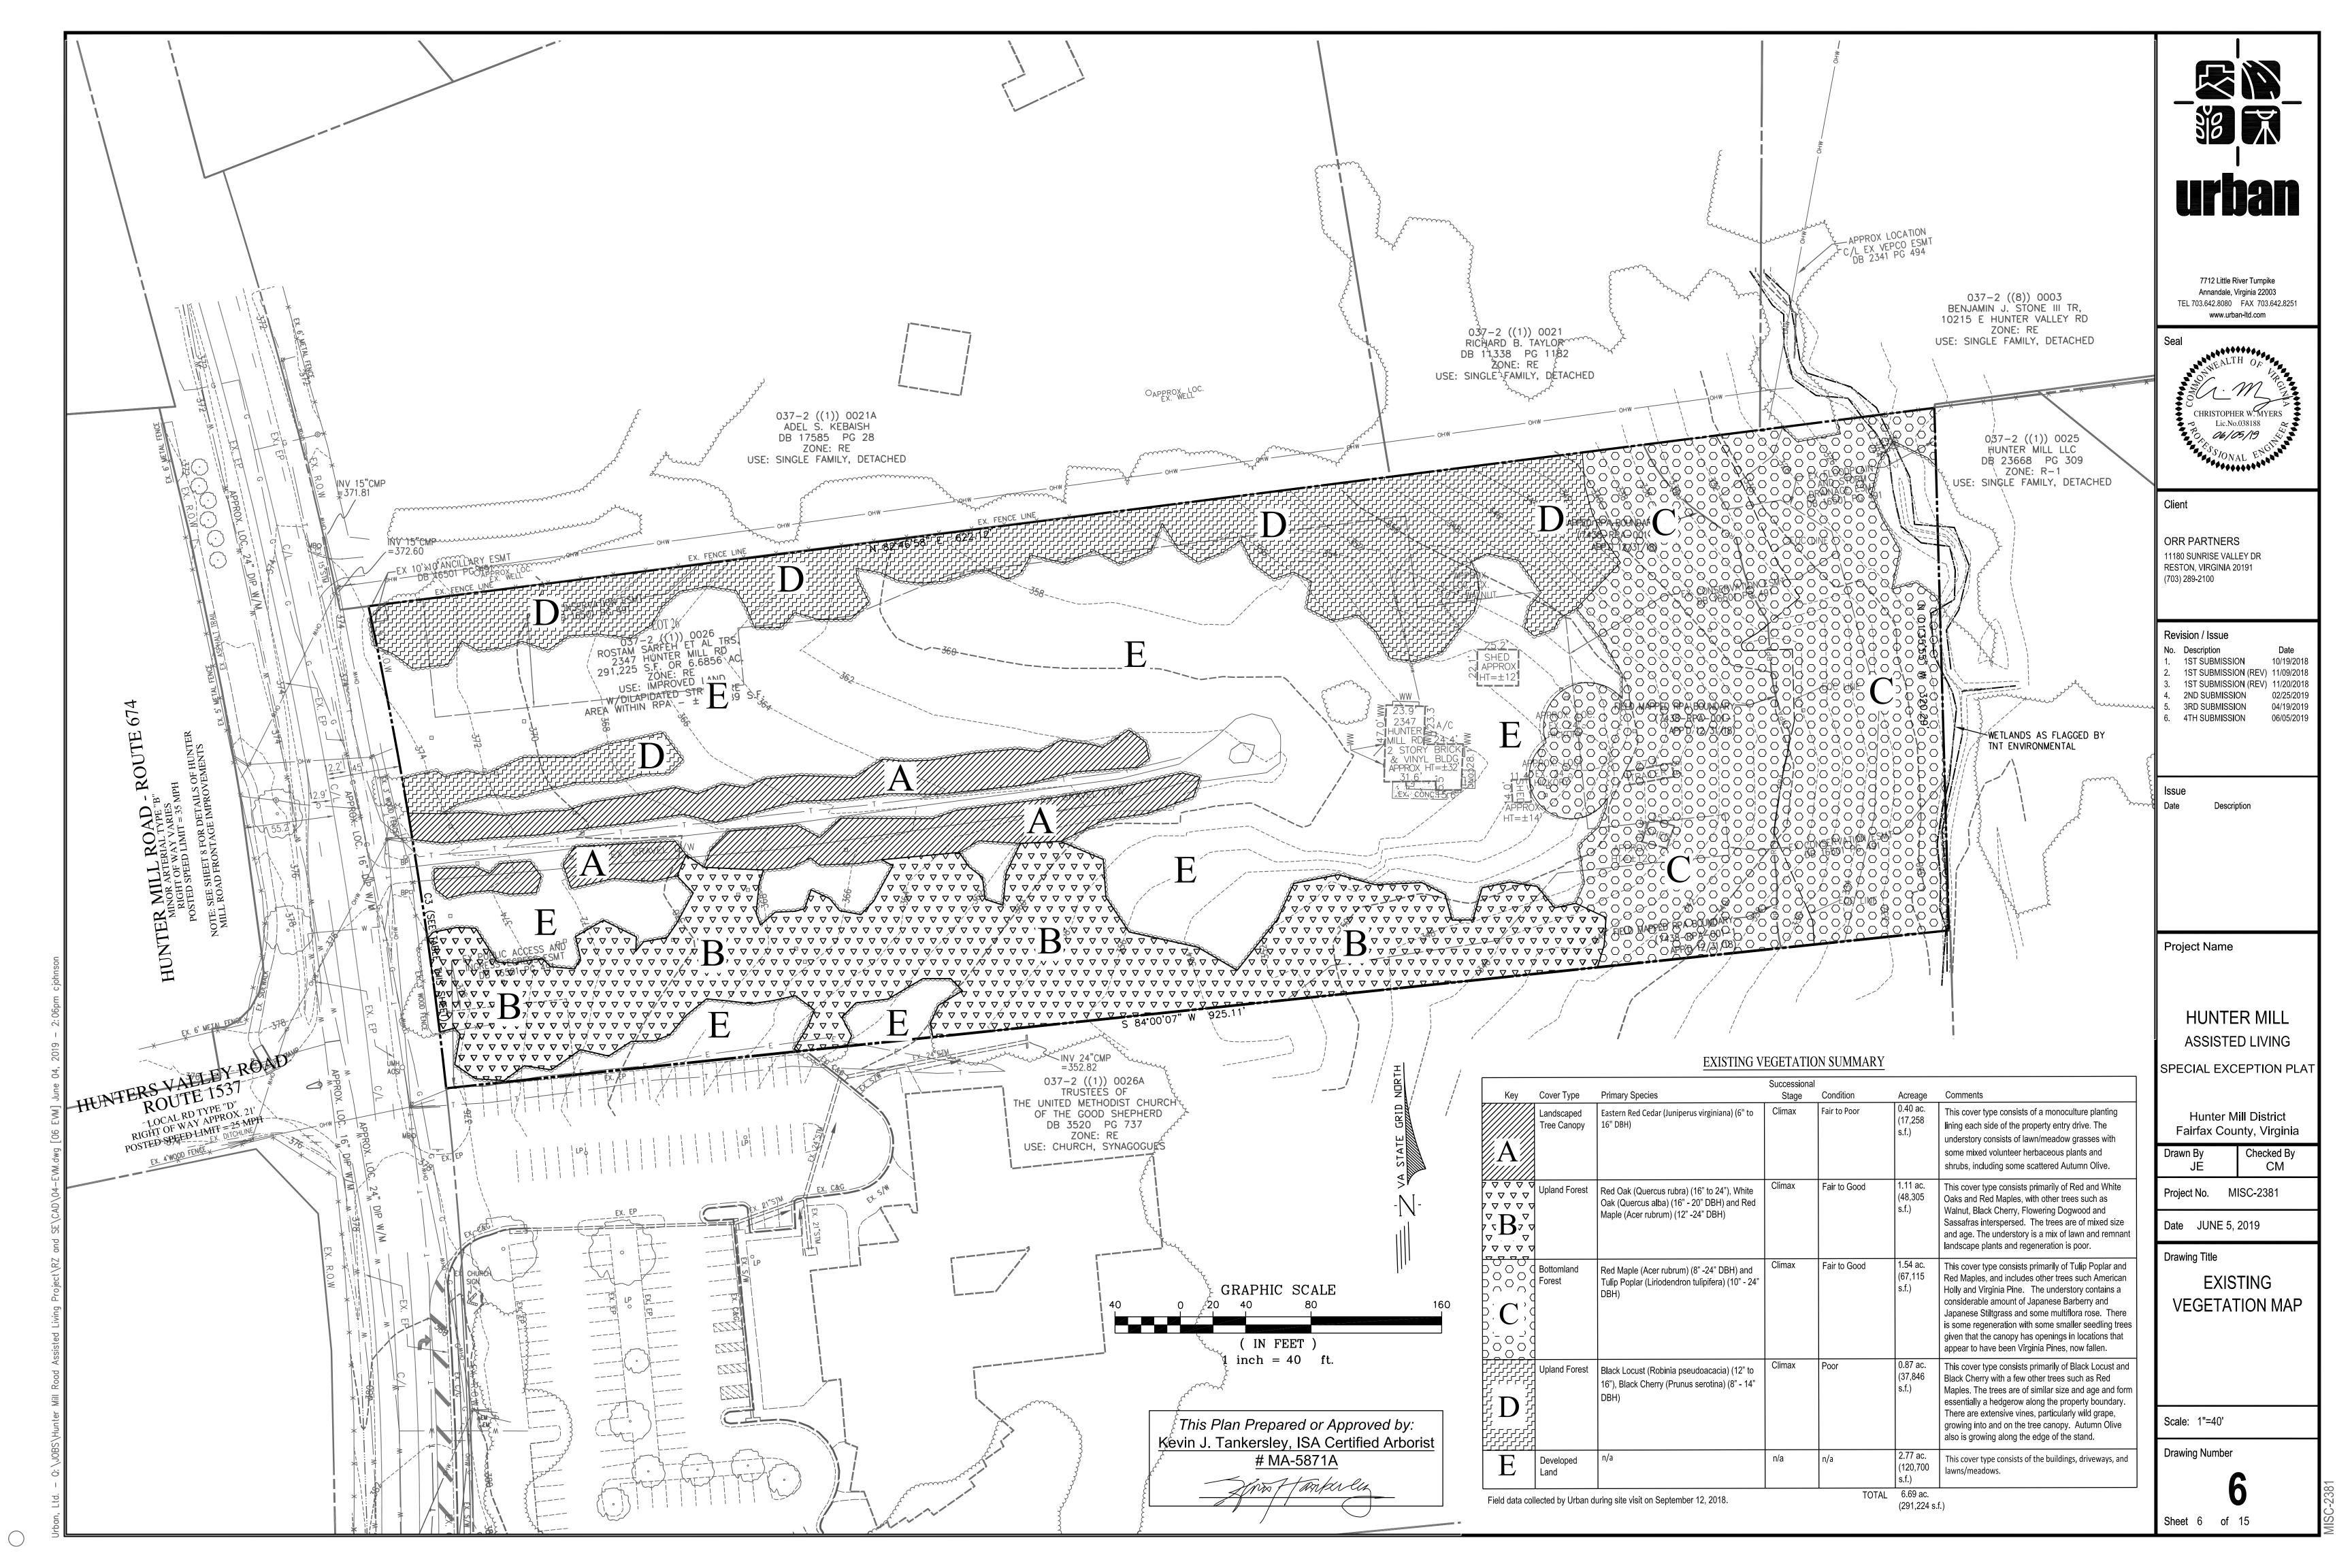


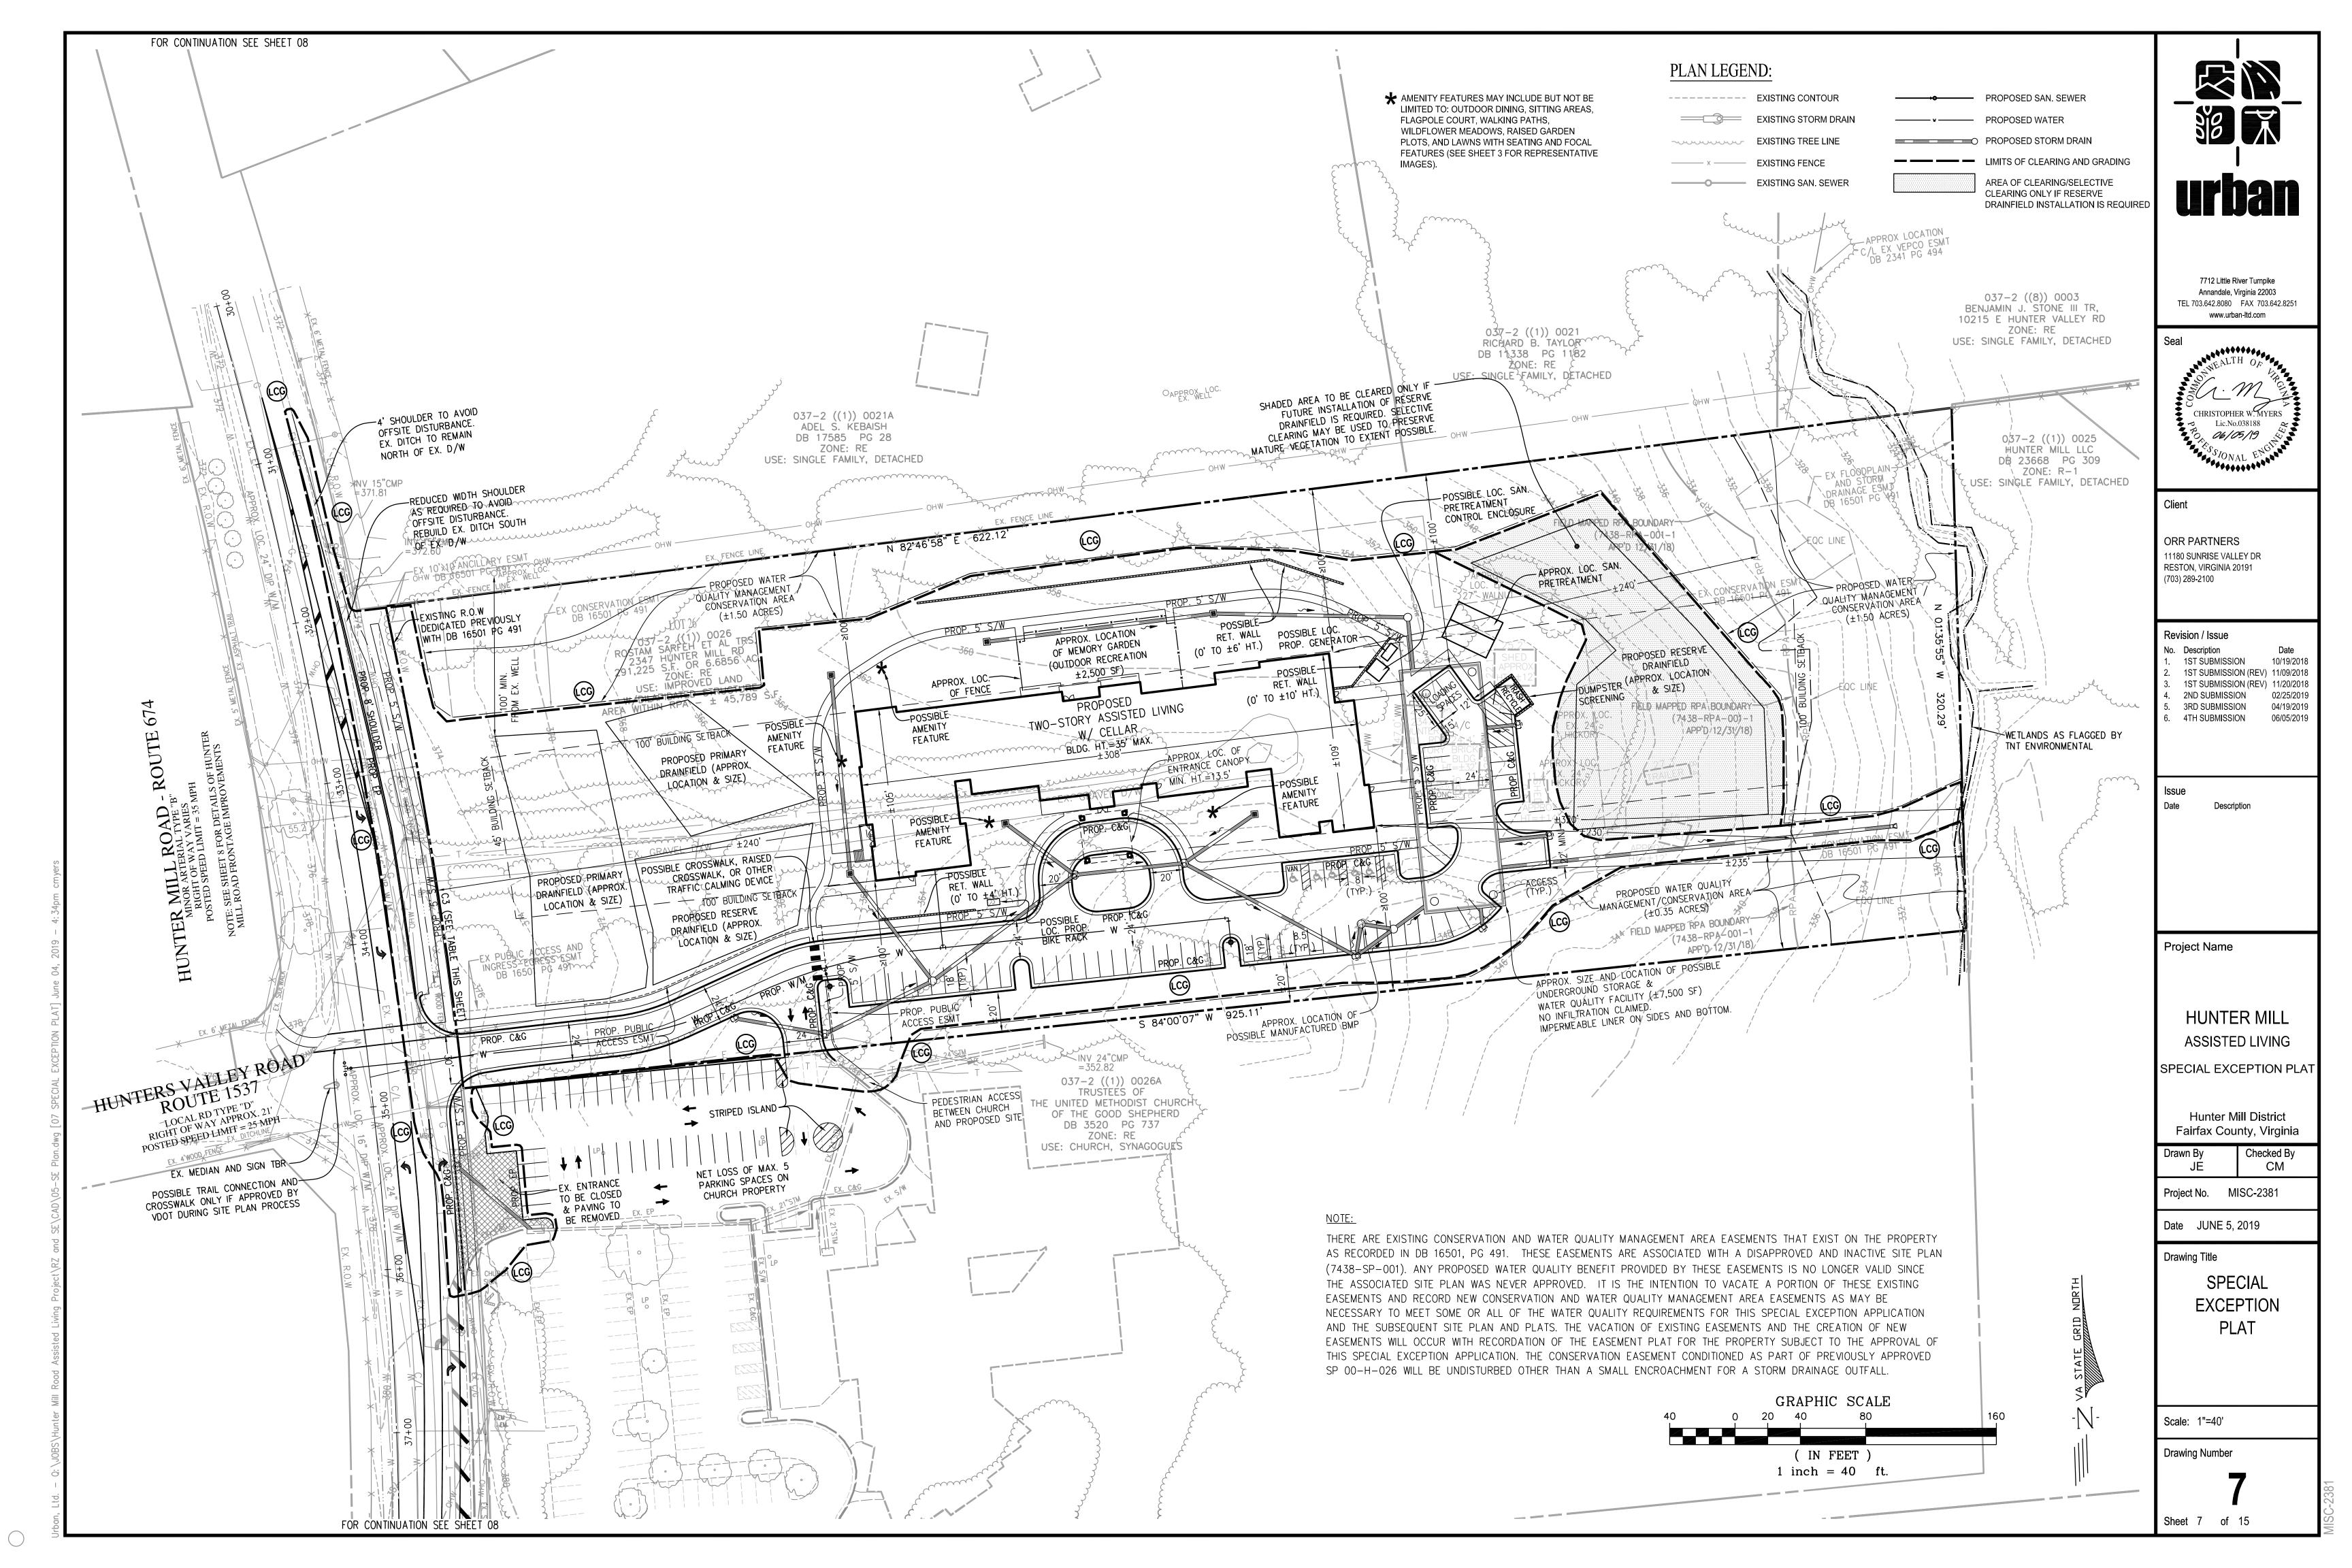


FIRE TRUCK ACCESS FAIRFAX COUNTY 47.5' UNIBODY TRUCK

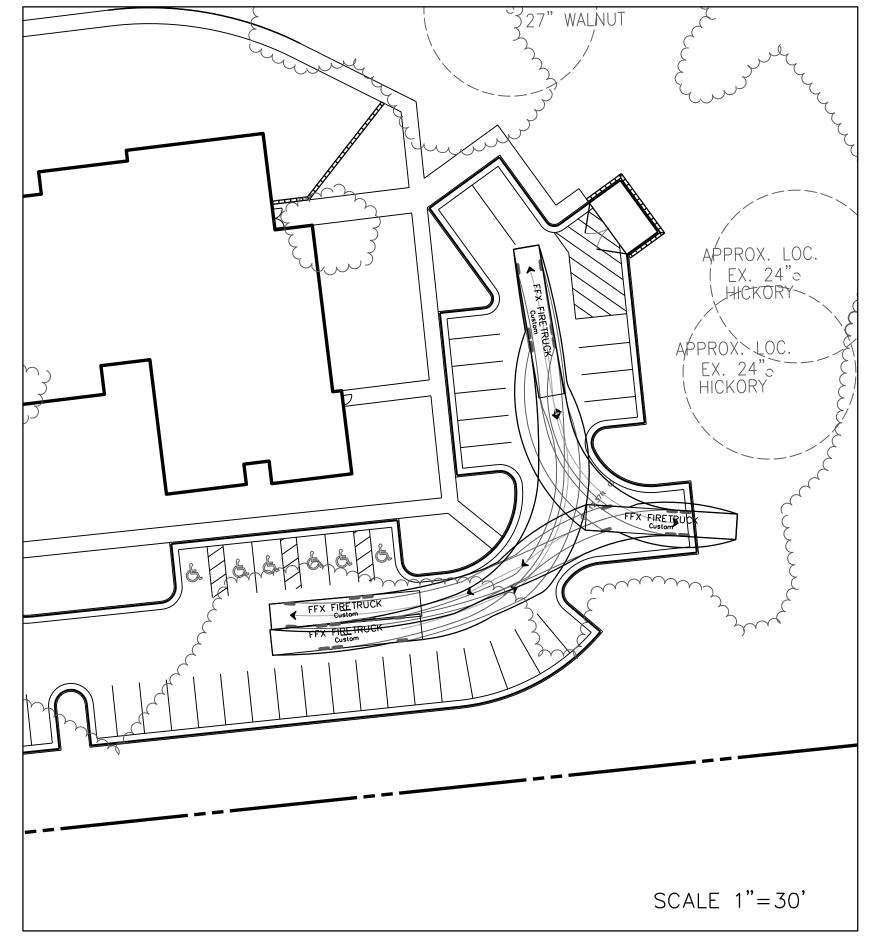

SERVICE VEHICLE ACCESS

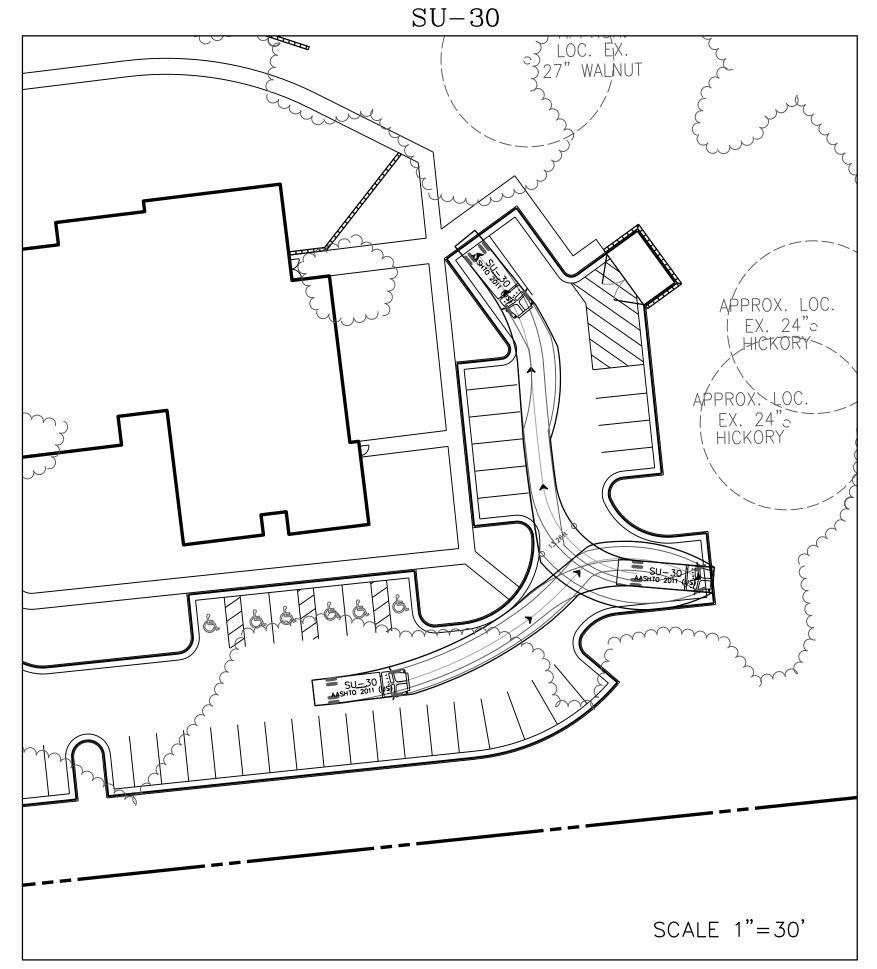

DUMPSTER VEHICLE ACCESS

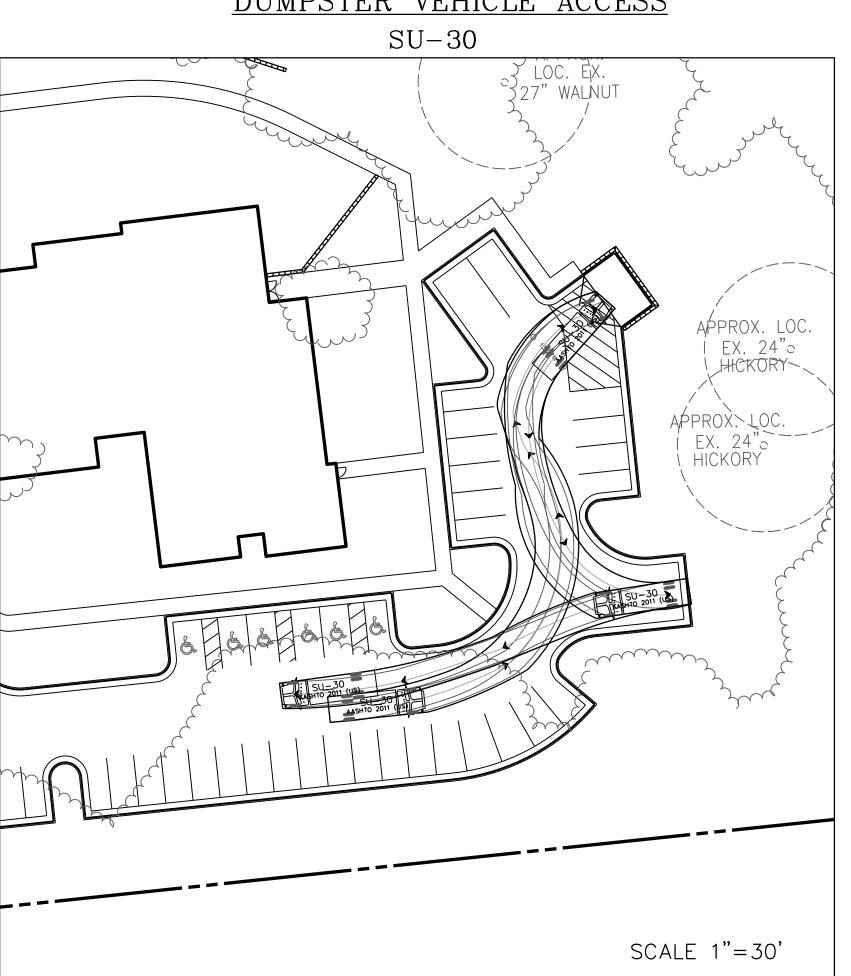

7712 Little River Turnpike Annandale, Virginia 22003 TEL 703.642.8080 FAX 703.642.8251 www.urban-ltd.com



Client

ORR PARTNERS 11180 SUNRISE VALLEY DR RESTON, VIRGINIA 20191 (703) 289-2100

 Revision / Issue

 No.
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 1.
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 3.
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 11/20/2018

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 2ND SUBMISSION
 02/25/2019

 5.
 3RD SUBMISSION
 04/19/2019

 6.
 4TH SUBMISSION
 06/05/2019

Issue

Project Name

HUNTER MILL ASSISTED LIVING

SPECIAL EXCEPTION PLAT

Hunter Mill District Fairfax County, Virginia

rawn By Checked By
JE CM

Date JUNE 5, 2019

Project No. MISC-2381

Drawing Title


TURNAROUND MOVEMENT EXHIBIT


Scale: AS SHOWN

Drawing Number

7A
Sheet 7A of 15

VA STATE GRID NORTH

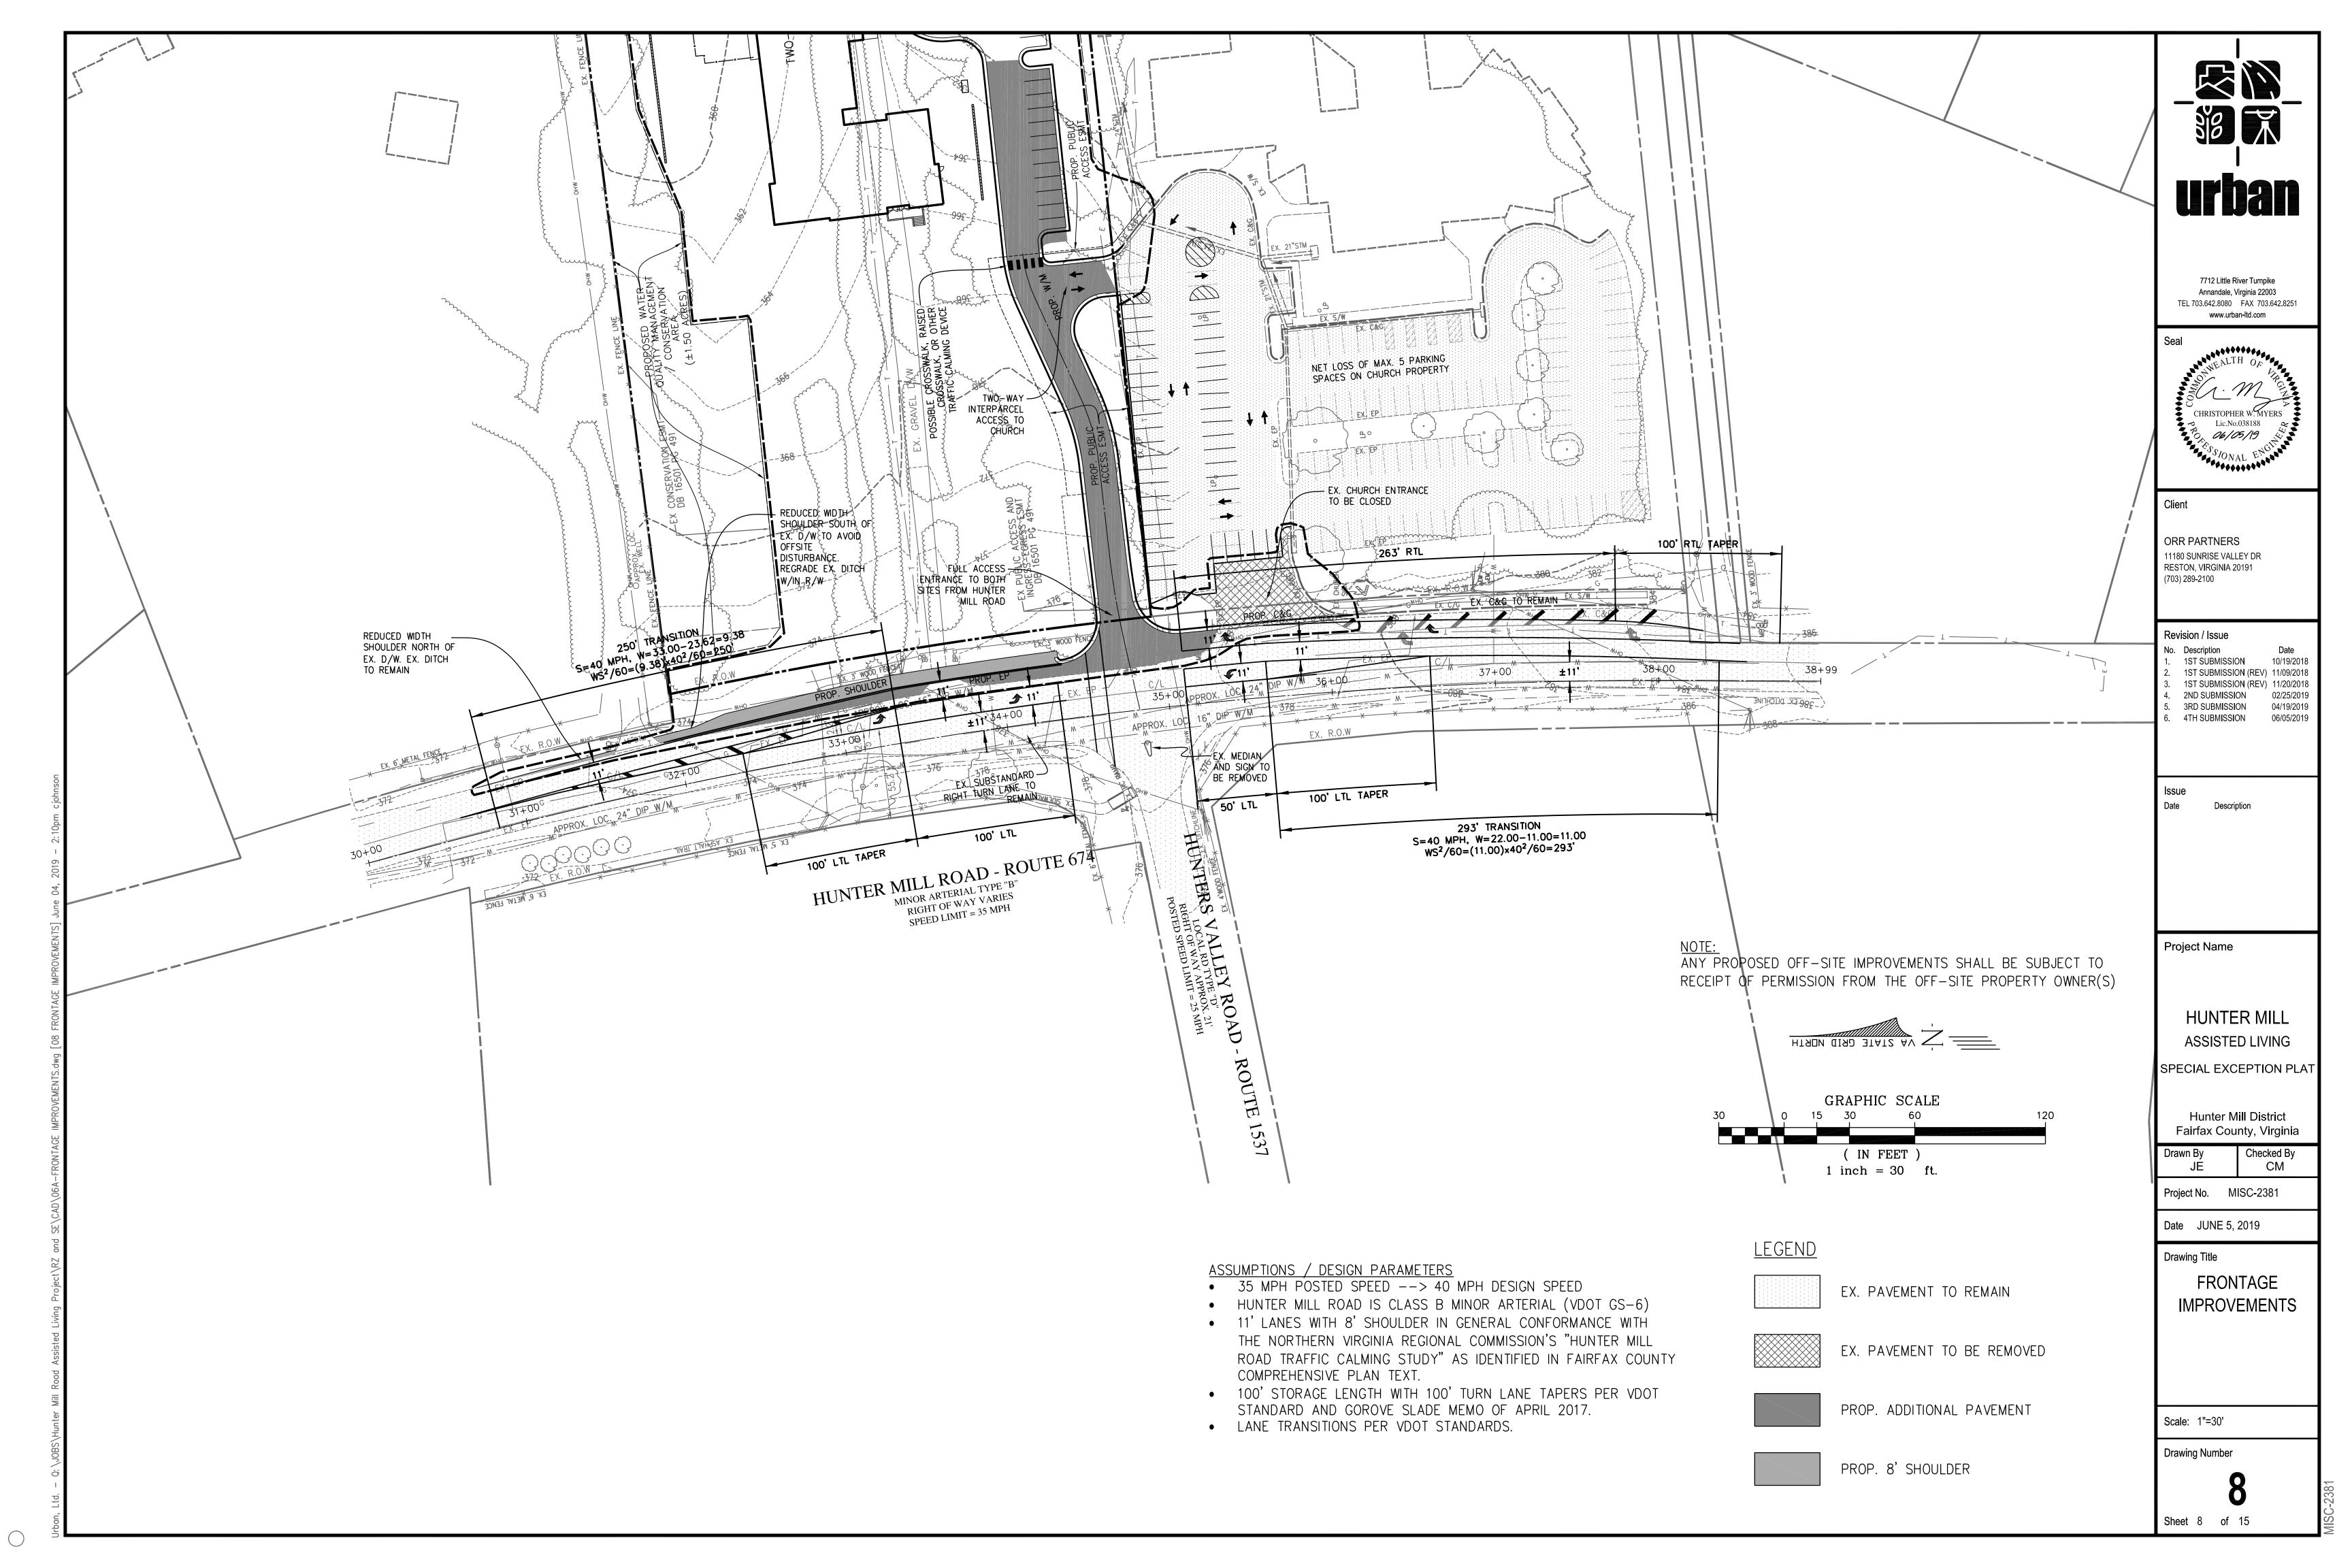

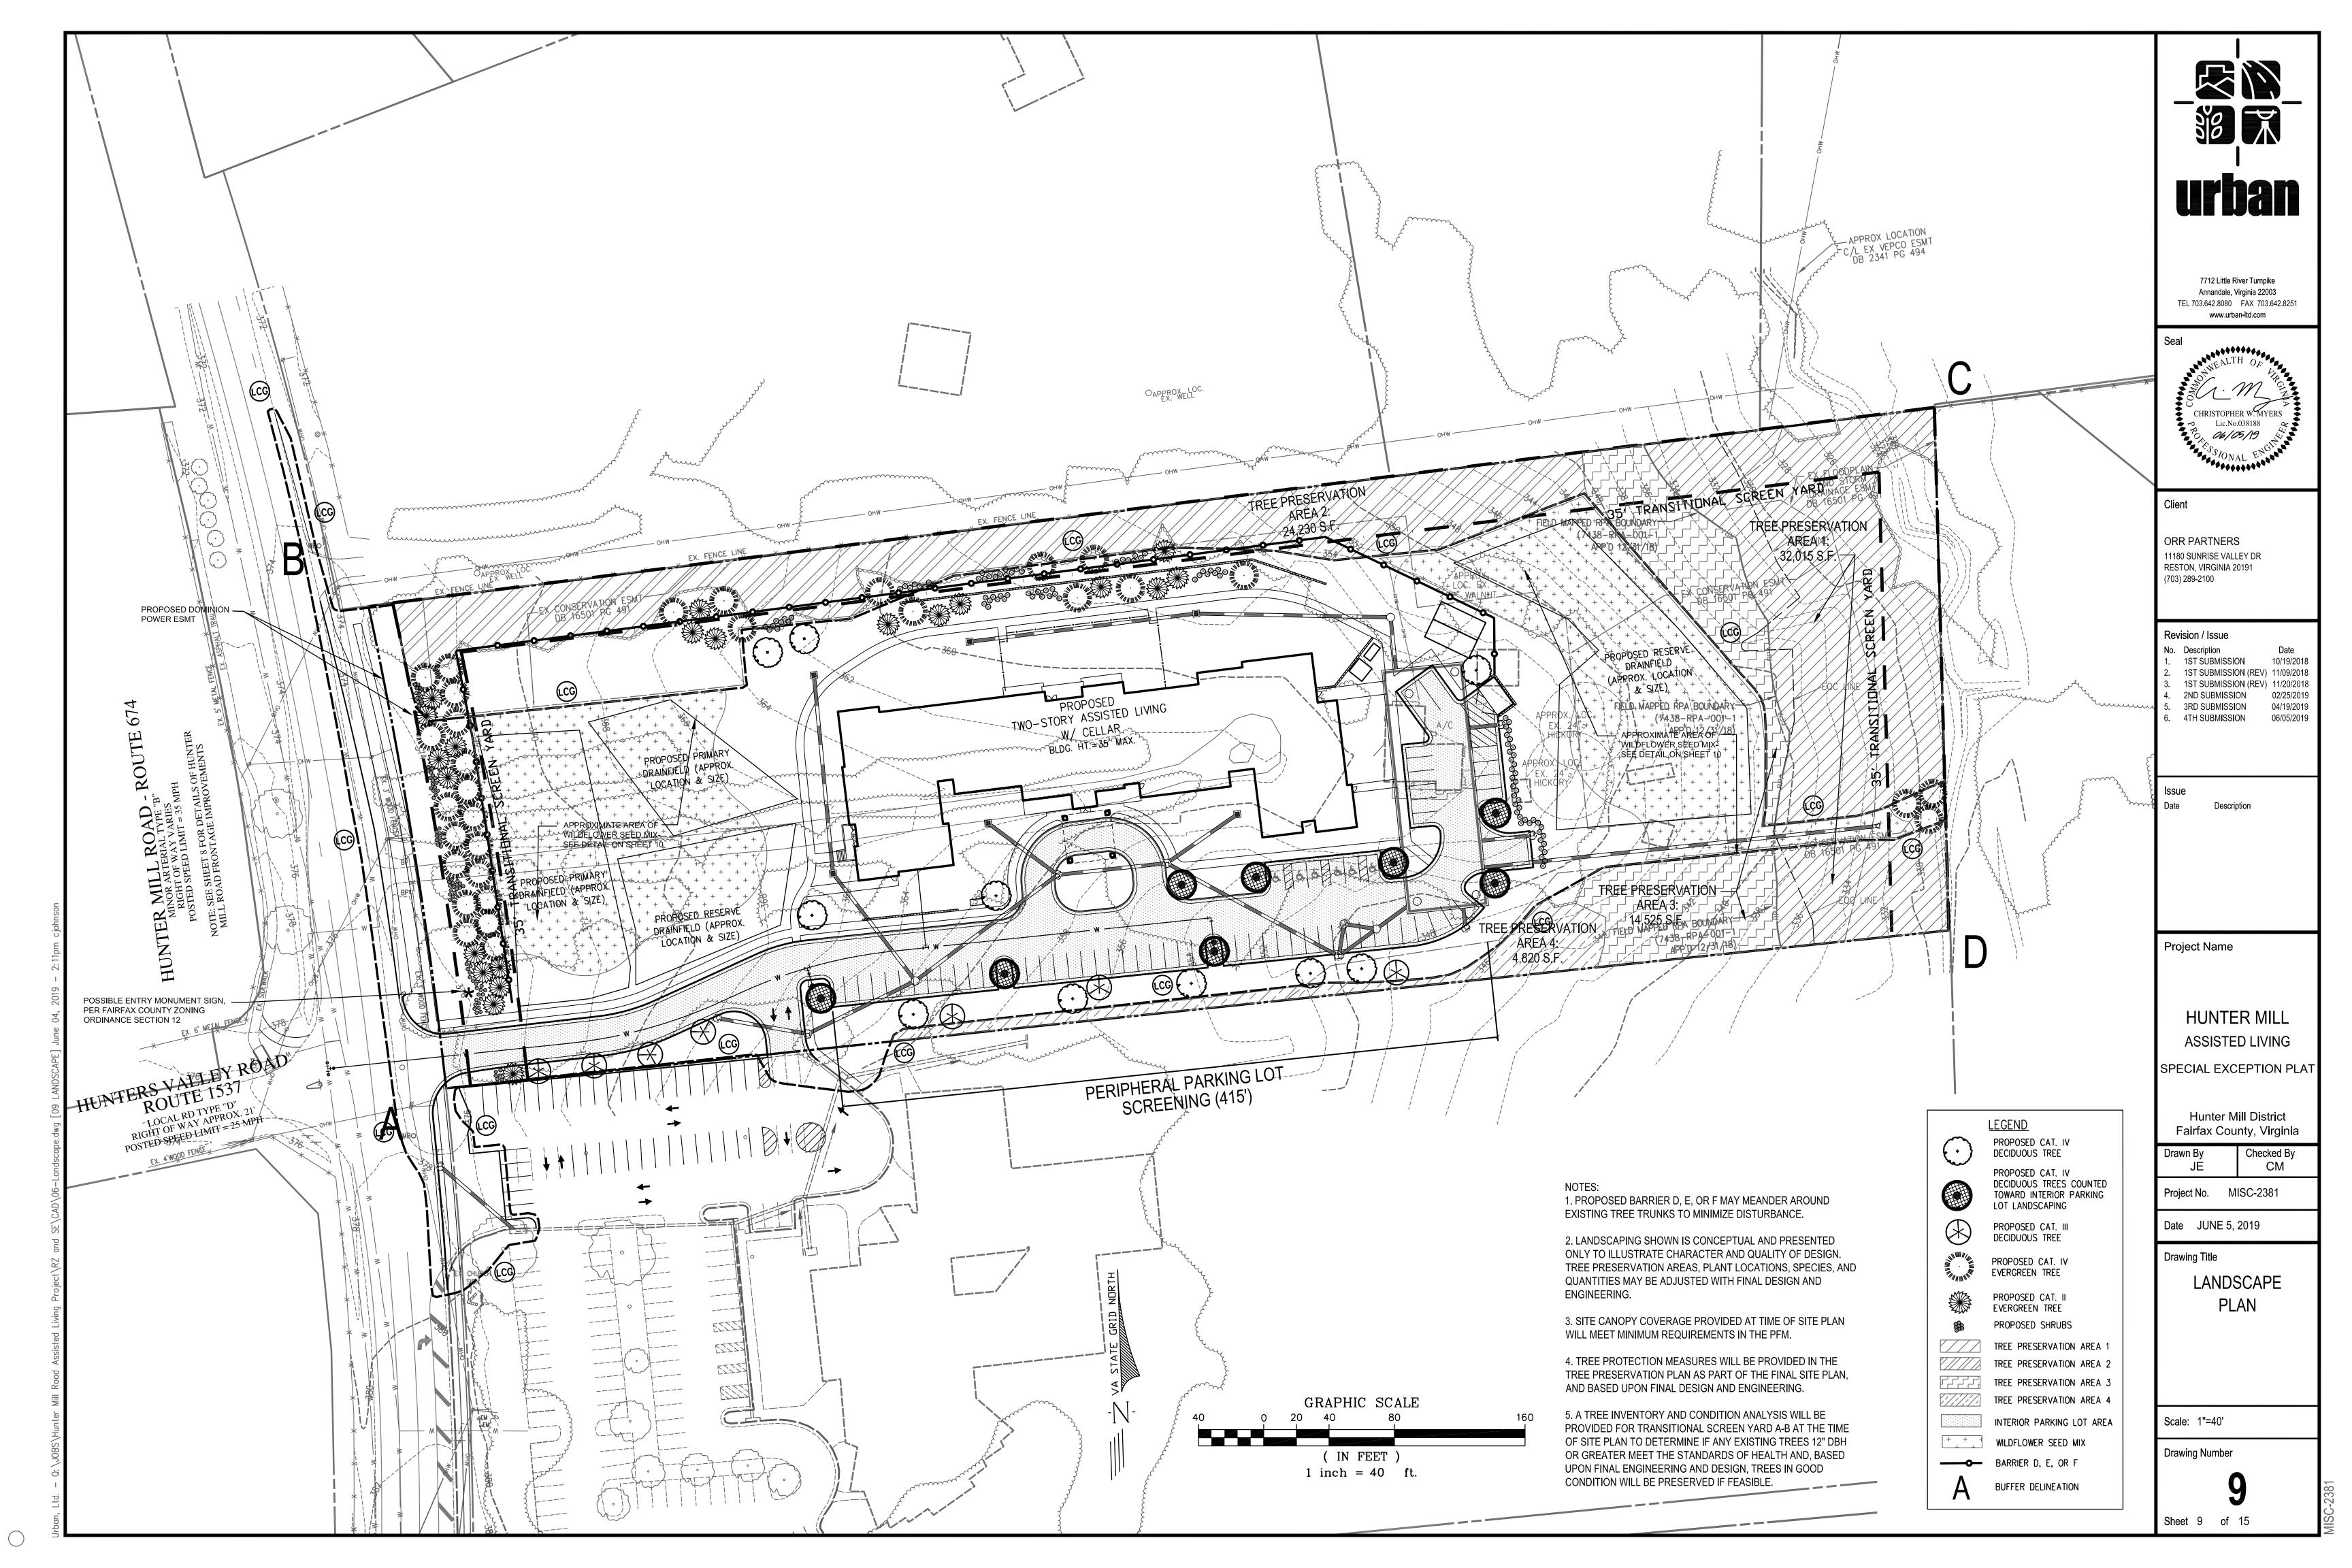



CHARACTER OF BARRIER WITHIN TRANSITIONAL SCREEN YARD A-B



CHARACTER OF BARRIER WITHIN TRANSITIONAL SCREEN YARD B-C

BARRIER FENCE DETAILS:

BARRIER FENCE MAY BE CONSTRUCTED OF WOOD, VINYL, COMPOSITE FENCING MATERIALS, BRICK, OR COMBINATION THEREOF.



WILDFLOWER SEED MIX DETAILS:

WILDFLOWER SEED MIX TO BE INSTALLED IN INFORMAL DRIFTS ACROSS DRAINFIELDS. GENERALLY AS SHOWN ON PLAN.

Tree Preservation Target (%)										
Tree Preservation Target (s.f.)				42,773						
Tree Preservation:										
Tree Preservation Areas	Cover Type	<u>S.F.</u>	Credit Factor	Tota						
Tree Preservation Area 1	Bottomland Forest (RPA)	32,015	1.00	32,015						
Tree Preservation Area 2	Upland Forest	24,230	1.00	24,230						
Tree Preservation Area 3	Bottomland Forest	14,525	1.25	18,156						
Tree Preservation Area 4	Upland Forest	4,820	1.00	4,820						

PLANT SCHEDULE										
Symbol	Botanical Name	Common Name	Size	Туре	Remarks	10 yr. Canopy Credit	Multiplier			
	Cat. IV Deciduous Trees					l				
	Acer rubrum	Red Maple	3" Cal.	B & B	Uniform branching pattern	250	Native: 1.50			
~~~	Carya glabra	Pignut Hickory	3" Cal.	В&В	Uniform branching pattern	250	Native: 1.50			
	Fagus grandifolia	American Beech	3" Cal.		Uniform branching pattern	250				
£ + }	Liriodendron tulipfera	Tulip Poplar	3" Cal.	В&В	Uniform branching pattern	250				
<b>Y</b> 3	Platanus occidentalis	Sycamore	3" Cal.		Uniform branching pattern	250				
Jacob Company	Quercus alba	White Oak	3" Cal.	В&В	Uniform branching pattern	250	Wildlife Benefits: 1.5			
18	Quercus coccinea	Scarlet oak	3" Cal.		Uniform branching pattern	250	Native: 1.5			
	Quercus phellos	Willow Oak	3" Cal.		Uniform branching pattern	250	Wildlife Benefits: 1.5			
	Tilia americana	American Linden	3" Cal.		Uniform branching pattern	250				
	Cat. III Deciduous Trees	ID: on Direct	1011 O -1	ID 0 D	Distance because in a settlem	475	Mildlife Demoster 4 5			
	Cat. III Deciduous Trees Betula nigra Gleditsia triacanthos 'inermis' Nyssa sylvatica	River Birch Thornless Honeylocust Black Gum	3" Cal. 3" Cal. 3" Cal.	В&В	Uniform branching pattern Uniform branching pattern Uniform branching pattern	175 175 175				
7	Betula nigra Gleditsia triacanthos 'inermis'	Thornless Honeylocust	3" Cal.	В&В	Uniform branching pattern	175				
7	Betula nigra Gleditsia triacanthos 'inermis' Nyssa sylvatica  Cat. IV Evergreen Trees	Thornless Honeylocust	3" Cal. 3" Cal.	B & B B & B	Uniform branching pattern Uniform branching pattern	175	Wildlife Benefits: 1.5 Wildlife Benefits: 1.5			
7	Betula nigra Gleditsia triacanthos 'inermis' Nyssa sylvatica	Thornless Honeylocust	3" Cal.	B & B B & B	Uniform branching pattern Uniform branching pattern Uniform branching pattern Uniform branching pattern	175				
7	Betula nigra Gleditsia triacanthos 'inermis' Nyssa sylvatica  Cat. IV Evergreen Trees	Thornless Honeylocust Black Gum	3" Cal. 3" Cal.	B & B B & B	Uniform branching pattern Uniform branching pattern	175 175				
7	Betula nigra Gleditsia triacanthos 'inermis' Nyssa sylvatica  Cat. IV Evergreen Trees Magnolia grandiflora	Thornless Honeylocust Black Gum  Southern Magnolia	3" Cal. 3" Cal.	B & B B & B B & B B & B	Uniform branching pattern Uniform branching pattern Uniform branching pattern Uniform branching pattern	175 175 250	Wildlife Benefits: 1.5			

	182					
PERIPHERA	L PARKING LO	T LANDSCAPIN	IG CALCULATIONS	Table 12.11 Interior Parking Lot	: Landscaping Ca	lculations
Location (Abutting	Use) Length (I.f	) Required Trees	Provided Trees		ft²	Remarks
outh (Abutting Non-R.	, , ,	<u> </u>	5 Cat. IV Deciduous	Area to be counted (SF) =	33,686	S.F.
Outil (Abutting Non-R.	0.00.) 415	o frees (1/50 f.f.)	3 Cat. III Deciduous	Interior Landscaping Required (5%) =	1,685	S.F.
				Total Tree Occurrence Provide de		
			8 Total Trees Provided	Total Tree Canopy Provided:		
				(8 trees @ 250 ft ² ea.) =	2,000	S.F.

Oakleaf Hydrangea

Arrowwod Viburnum

			TRANSITIO	NAL S	CREENING A	ND BARRIER CALCULATIONS	3		
Adjacent Use (Group)	Required Transitional Screening / Barrier	Width (l.f.)	Length (l.f.)	Area (s.f.)	Required 10- Year Canopy Cover (75%)	Required Trees and Shrubs		Provided Trees and Shrubs	Total Canopy
West: Buffer A-B Assisted Living to Single Family Detached (Group 1)	Type 2; D, E, or F	35	275 Subtotal	9,625	7,219 (Mixture of large & medium evergreen trees)	20 Cat IV Evergreen Trees @ 250 s. 18 Cat II Evergreen Trees @ 125 s.	f. 11	Cat IV Evergreen Trees @ 250 s.f. Cat II Evergreen Trees @ 125 s.f. s.f. Existing Canopy to be Preserved	4,500 s.t 1,375 s.t 1,410 s.t
					3 Shrubs /10 l.f.	83 Shrubs Barrier D, E, or F	83	Shrubs Barrier D, E, or F	
Total							· •		7,285 s.1
Requirement is met	7,285	s.f. is g	reater than	7,219					
NOTE: The full 35' width o	f Transitional Screer	Yard A	-B has been pr	ovided	immediately bel	nind the 15' overhead electric line ea	sement		
North: Buffer B-C Assisted Living to Single Family Detached (Group 1)	Type 2; D, E, or F	35	966 Subtotal	33,810	25,358 (Mixture of large & medium evergreen trees)	70 Cat IV Evergreen Trees @ 250 s. 63 Cat II Evergreen Trees @ 125 s.	f. 10	Cat IV Evergreen Trees @ 250 s.f. Cat II Evergreen Trees @ 125 s.f. s.f. Existing Canopy to be Preserved	2,500 s. 1,250 s. 27,155 s.
					3 Shrubs /10 l.f.	290 Shrubs	62	2 Shrubs	
					0 0111000 7 10 1.1.	Barrier D, E, or F		Barrier D, E, or F; See note 2.	
Total				:				24. Her 2, 2, 6, 1, 666 Hete 2.	30,905 s.1
Requirement is met	30,905	s.f. is g	reater than	25,358			-		
•	,								
East: Buffer C-D	T 0 D E E	35	320 Subtotal	11,200	(Mixture of large	24 Cat IV Evergreen Trees @ 250 s. 20 Cat II Evergreen Trees @ 125 s.	f. C	Cat IV Evergreen Trees @ 250 s.f. Cat II Evergreen Trees @ 125 s.f. s.f. Existing Canopy to be Preserved	750 s.t 0 s.t 7,875 s.t
Assisted Living to Single Family Detached (Group 1)	Type 2; D, E, or F				& medium evergreen trees)		7,075	5 S.I. Existing Canopy to be Preserved	7,070 3.1
	Type 2; D, E, or F					96 Shrubs		Shrubs	7,070 3.1
	Type 2; D, E, or F				evergreen trees)	96 Shrubs Barrier D, E, or F		, ,	
					evergreen trees)			Shrubs	8,625 s.1
Family Detached (Group 1)		s.f. is gi	reater than	8,400	evergreen trees) 3 Shrubs /10 l.f.			Shrubs	
Family Detached (Group 1) Total		s.f. is gr	reater than	8,400	evergreen trees) 3 Shrubs /10 l.f.			Shrubs	

- 1. MODIFICATION OF THE TRANSITIONAL SCREENING REQUIREMENT ALONG NORTHERN AND EASTERN EDGES (B-C-D) TO ALLOW THE USE OF EXISTING TREES WHERE FEASIBLE MAY BE REQUESTED AT TIME OF SITE PLAN.
- 2. A MODIFICATION OF THE BARRIER REQUIREMENT IS REQUESTED FOR THE EASTERN PROPERTY LINE AND A PORTION OF THE NORTHERN PROPERTY LINE WHERE DUE
- TO THE TOPOGRAPHY, THE BARRIER WILL NOT BE EFFECTIVE.

Cat. Il Evergreen Trees

Shrubs
Clethra alnifolia 'Hummingbird' | Summersweet

Juniperus virginiana

Hydrangea quercifolia

Myrica pensylvanica

Viburnum dentatum

llex opaca

llex glabra

3. PLANTINGS PROVIDED TO SUPPLEMENT THE EXISTING VEGETATION WITHIN TRANSITIONAL SCREEN YARD B-C AND C-D SHALL BE FIELD LOCATED TO AVOID CONFLICTS WITH EXISTING VEGETATION.

Step		Totals	Reference
A. Tre	e Preservation Target Calculations and Statement		
Α	Pre-development area of existing tree canopy (from existing vegetation map) (SF) =	166,309	see § 12-0307.2
В	Percentage of gross site area covered by existing tree canopy =	57%	
С	Percentage of 10-year tree canopy required for site =	30%	see Table 12.4
D	Percentage of the 10-year tree canopy requirement that should be met through tree preservation =	57%	
E	Proposed percentage of canopy requirement that will be met through tree preservation =	104.7%	
F	Has the Tree Preservation Target minimum been met?	Yes	Provide Yes or No
G	If No for line F, then a request to deviate from the Tree Preservation Target shall be provided on the plan that states one or more of the justifications listed in § 12-0308.3 along with a narrative that provides a site-specific explanation of why the Tree Preservation Target cannot be met. Provide sheet number where deviation request is located.	n/a	Provide sheet number, see § 12-0308.3
Н	If step G requires a narrative, it shall be prepared in accordance with § 12-0308.4	n/a	see § 12-0308.4
I	Place this information prior to the 10-year Tree Canopy Calculations as per instructions in Table 12.10.	✓	

Step		Totals	
Α.	Tree Preservation Target and Statement		
A 1	Place the Tree Preservation Target calculations and statement here preceeding the 10-year tree canopy	✓	see § 12-0308.2 for list of required elements and worksheet
р т	ree Canany Paguirament		

Subtract area dedicated to parks, road frontage (SF) = 0 § 12-0311.1B

Total canopy area meeting standards of § 12-0400 (SF) = 14,525 Square Feet

"Specimen," or "Street" trees (SF) =

communities (SF) =

C 6 x 1.5 to 3.0 (SF) =

D 2 x 1.5 (SF)

D4 x 1.5 (SF)

D 6 x 1.25 (SF)

D8 x 1.5 (SF) =

D 10 x 1.5 (SF) =

D 12 x 1.25 (SF)

D 14 x 1.0 =

D 15 x 1.0 =

tree fund =

Fund =

C 4 x 1.5 (SF) =

Identify gross site area (SF) = 291,224 § 12-0311.1A

18,156 § 12-0310.3B

§ 12-0310.3B(1)

B 7 remainder of requireent must be met through tree

0 § 12-0310.3B(2)

Square feet

Square feet § 12-0310.4B(2)

Square feet 0 § 12-0310.4B(3)

> Square feet § 12-0310.4B(4)

Square feet 0 § 12-0310.4B(5)

Square feet

0 § 12-0310.4D(1)

0 Square feet

15,850 | Square feet

No Yes or No

(E1+E2+E3) 95,071 area should meet or

No Yes or No § 12-0312

0.0%

§ 12-0310.4B(6)

Must not exceed 33% of D

Total of E 1 through E 3,

exceed area in B 7

§ 12-0310.4B(1)

Total of C 3, C 5, C 7, C 9, and C 9A (SF) = 79,221 If area of C 10 is less than

В3	Subtract area of exemptions (SF) =	39,065	§ 12-0311.1C(1) through § 12-0311.1C(6)
В4	Adjusted gross site area (B1-B2,B3) (SF) =	252,159	Square feet
B5	Identify the site's zoning and/or use	R-E	
B6	Percentage of 10-year tree canopy required =	30.0%	§ 12-0310.1 and Table 12.4
B7	Area of 10-year Tree Canopy Required (B4 x B6) (SF) =	75,648	Square feet
B8	Modification of 10-year Tree Canopy Requirements requested?	No	Yes or No
B9	If B8 is yes, then list plan sheet where modification request is located	n/a	Sheet number
C. Tre	ee Preservation		
C 1	Tree Preservation Target Area (SF) =	43,200	Square Feet

total of canopy area provided by "Heritage," "Memorial,"

Area of canopy to be met through tree planting (B 7-C 10) =

Area of canopy provided by improved cultivars and varieties :

Area of canopy provided through tree seedlings (SF) =

Area of canopy to be planted with no benefit credits =

Total of canopy area provided through tree planting =

Canopy area requested to be provided through offsite banking or

Amount to be deposited into the Tree Preservation and Planting

Area of canopy provided through native shrubs=

Percentage of D 14 represented by D 15 =

Is an offsite planting relief requested?

Tree Bank or Tree Fund?

Area of canopy planted for air quality benefits :

Area of canopy planted for energy conservation =

Area of canopy planted for water quality benefits =

Area of canopy planted for wildlife benefits =

Area of canopy provided by native trees =

C 4 Total canopy area provided by unique or valuable forest or woodland

					\ \ \ \ \ \ \ \ \ \ \ \ \ \ \ \ \ \ \	(	3 .2 00 .0.02(2
				C 8	Canopy area of trees within Resource Protection Areas and 100-	32,015	Square Feet
				1	year floodplains (SF) =	32,013	Square Feet
				C 9	C 8 x 1.0 (SF) =	32,015	§ 12-0310.3C(1)
ULATIONS	Table 12.11 Interior Parking Lot	Landscaping C	alculations	C 9A	Other areas of preserved tree canopy not receiving multiplier (SF) =	•	Square Feet
			Remarks	C 10	Total of C 3, C 5, C 7, C 9, and C 9A (SF) =	79,221	If area of C 10 is
vided Trees	Area to be counted (SF) =	33,686	S.F.	<b>-</b>		i	B 7 remainder of
Deciduous	,			4 <b>I</b>			must be met the
eciduous	Interior Landscaping Required (5%) =	1,685	S.F.				
		•				i	planting - go to
ees Provided	Total Tree Canopy Provided:						<del></del>
				<b>-</b>			1

B & B Uniform branching pattern

18"-24" Ht. B & B Full, dense

Total Area Required (SF) =

Total Area Provided (SF)=

18"-24" Ht. B & B Full, dense

			TDANSITIC	NIAI G	SCREENING A	ND BARRIER CALCULATIONS			D 3	
	T		INANSIIIC	JNAL	JUNE EN ING A	IND BARRIER CALCULATIONS		Γ	D 4	Area of canopy planted
Adia a set Has (Ossass)	Required	Width	1 41- (1.5)	Area	Required 10-	Demoised Trees and Observe	Burnish d Turner and Observe	Total	D 5	
Adjacent Use (Group)	Transitional	(l.f.)	Length (I.f.)	(s.f.)	Year Canopy Cover (75%)	Required Trees and Shrubs	Provided Trees and Shrubs	Canopy	D 6	Area of canopy planted t
	Screening / Barrier				Cover (75%)				D 7	
West: Buffer A-B		35	275 Subtotal	9,625	7,219	20 Cat IV Evergreen Trees @ 250 s.f.	18 Cat IV Evergreen Trees @ 250 s.f.	4,500 s.f.	D 8	Area of canopy pla
Assisted Living to Single	Type 2; D, E, or F				(Mixture of large	18 Cat II Evergreen Trees @ 125 s.f.	11 Cat II Evergreen Trees @ 125 s.f.	1,375 s.f.	D 9	
Family Detached (Group 1)					& medium		1,410 s.f. Existing Canopy to be Preserved	1,410 s.f.	D 10	Area of capany
					evergreen trees)					Area of canopy
					3 Shrubs /10 l.f.	83 Shrubs	83 Shrubs		D 11	
						Barrier D, E, or F	Barrier D, E, or F		D 12	Area of canopy provided by improve
Total								7,285 s.f.	D 13	
Requirement is met			reater than	7,219					D 14	Area of canopy provided thro
NOTE: The full 35' width o	f Transitional Screer	n Yard A	\-B has been pi	rovided	immediately be	hind the 15' overhead electric line eas	ement			
									D 15	Area of canony provid
North: Buffer B-C		35	966 Subtotal	33,810		70 Cat IV Evergreen Trees @ 250 s.f.		2,500 s.f.	פו ט	Area of canopy provid
Assisted Living to Single	Type 2; D, E, or F				(Mixture of large	63 Cat II Evergreen Trees @ 125 s.f.	10 Cat II Evergreen Trees @ 125 s.f.	1,250 s.f.		
Family Detached (Group 1)					& medium evergreen trees)		27,155 s.f. Existing Canopy to be Preserved	27,155 s.f.	D 16	Percentage of D
					3 Shrubs /10 l.f.	290 Shrubs	62 Shrubs			Area of canopy to be plante
						Barrier D, E, or F	Barrier D, E, or F; See note 2.		D 17	Total of canopy area provic
Total								30,905 s.f.	D 18	ls an offsite
Requirement is met	30,905	s.f. is g	reater than	25,358	}				D 19	is an onsite
	•									
East: Buffer C-D		35	320 Subtotal	11,200	8,400	24 Cat IV Evergreen Trees @ 250 s.f.	3 Cat IV Evergreen Trees @ 250 s.f.	750 s.f.	D 20	Canopy area requested to be provided
Assisted Living to Single	Type 2; D, E, or F				(Mixture of large	20 Cat II Evergreen Trees @ 125 s.f.	0 Cat II Evergreen Trees @ 125 s.f.	0 s.f.		
Family Detached (Group 1)					& medium evergreen trees)		7,875 s.f. Existing Canopy to be Preserved	7,875 s.f.	D 21	Amount to be deposited into the Tree
					3 Shrubs /10 l.f.	96 Shrubs	0 Shrubs			
						Barrier D, E, or F	Barrier D, E, or F; See note 2.		E. Tota	al of 10-year Tree Canopy Provided
Total		1		1				8,625 s.f.	E 1	Total of canopy area provided through
Requirement is met	8,625	s.f. is g	reater than	8,400					E 2	Total of canopy area provided thro
-									E 3	Total of canopy area provided through o
South: Buffer D-A Assisted Living to Church (Group 4)	None Required								E 4	Total of 10-year Tre
NOTES:									NOTES	:

D. Tree Planting

5%

5.9%

2,000

1. THE PLANT LIST REPRESENTS A GENERAL PALETTE OF PROPOSED PLANT MATERIAL FOR THE SITE, THOUGH IT IS NOT INTENDED TO BE FULLY INCLUSIVE OF ALL VARIETIES THAT MAY BE PLANTED. FINAL PLANT LIST SELECTIONS WILL INCLUDE SPECIES LISTED IN PFM 12-0000, TABLE 12.19 OR AS OTHERS APPROVED BY UFMD AT THE TIME OF SITE PLAN.

Total of canopy area provided through tree preservation (C 10) = 79,221 | Square Feet Total of canopy area provided through tree planting (D 17) = 15,850 Square Feet

Total of canopy area provided through offsite mechanism (D 19) = 0 Square Feet Total of 10-year Tree Canopy Provided (SF)=

- QUANTITIES OF TREES WITH AND WITHOUT CANOPY MULTIPLIERS MAY BE ADJUSTED WITH FINAL SITE PLAN. TOTAL CANOPY REQUIRED WILL BE PROVIDED WITH FINAL SITE PLAN. INSTALLED SIZES OF TREES MAY VARY TO INCLUDE 2" AND 3" CALIPER PLANTS TO IMPROVE CHANCES OF SURVIVABILITY AND PROVIDE A VARIABLE CANOPY FOR FUTURE GROWTH. THE GENERAL DENSITY OF TREES SHOWN AND MINIMUM CANOPY COVERAGE REQUIREMENTS SPECIFIED IN THE PUBLIC FACILITIES MANUAL WILL BE PROVIDED.
  - THIS PLAN REFLECTS THE GENERAL CHARACTER AND INTENT OF THE PROPOSED DEVELOPMENT BASED ON PRELIMINARY ENGINEERING, ARCHITECTURAL AND LANDSCAPE ARCHITECTURAL DESIGN. MINOR VARIATIONS MAY OCCUR WITH FINAL BUILDING DESIGN AND SITE PLAN.

4. 39,065 S.F. EXEMPTED FOR PROPOSED DRAINFIELDS.

7712 Little River Turnpike Annandale, Virginia 22003 TEL 703.642.8080 FAX 703.642.8251 www.urban-ltd.com



Client

(703) 289-2100

ORR PARTNERS 11180 SUNRISE VALLEY DR RESTON, VIRGINIA 20191

Revision / Issue

No. Description 10/19/2018 1ST SUBMISSION 1ST SUBMISSION (REV) 11/09/2018 1ST SUBMISSION (REV) 11/20/2018 2ND SUBMISSION 02/25/2019 3RD SUBMISSION 04/19/2019 4TH SUBMISSION 06/05/2019

Issue

Project Name

**HUNTER MILL** ASSISTED LIVING

SPECIAL EXCEPTION PLAT

Hunter Mill District Fairfax County, Virginia

Checked By Drawn By

Project No. MISC-2381

Date JUNE 5, 2019


Drawing Title

LANDSCAPE **COMPUTATIONS** 

Scale: AS SHOWN

Drawing Number

Sheet 10 of 15

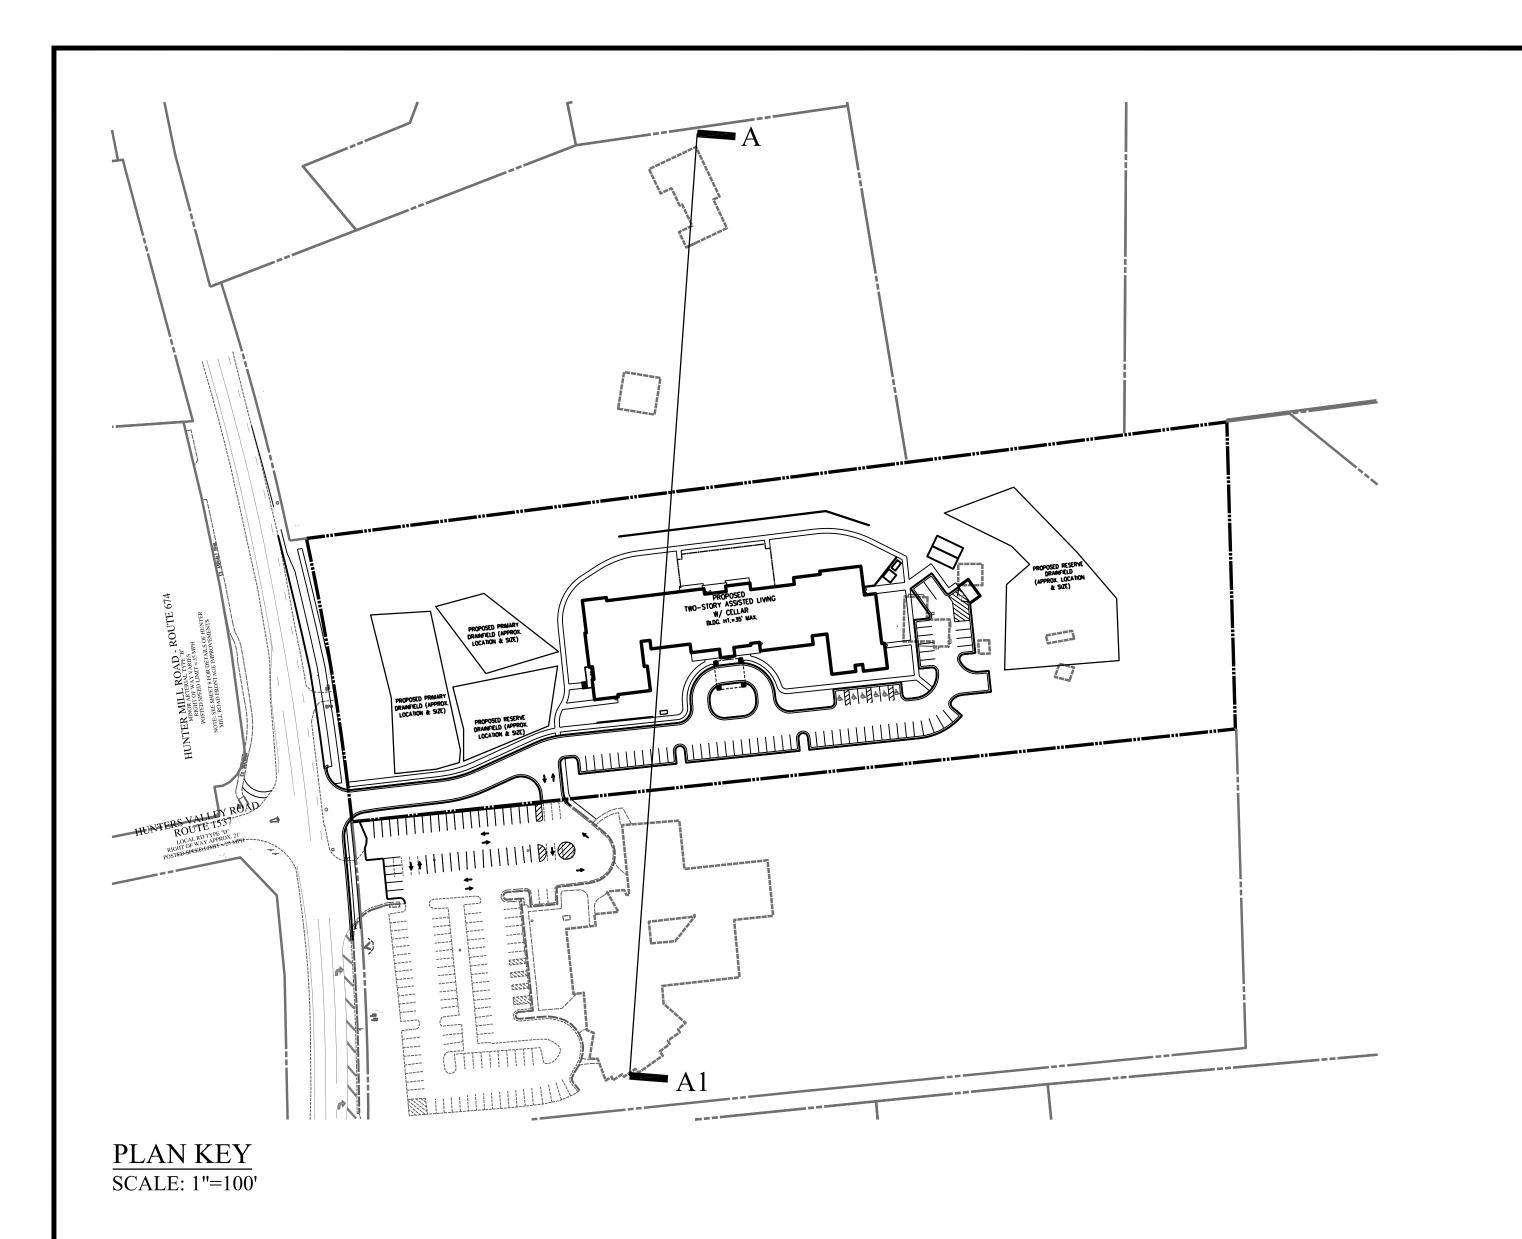

7712 Little River Turnpike Annandale, Virginia 22003 TEL 703.642.8080 FAX 703.642.8251 www.urban-ltd.com

CHRISTOPHER W. MYERS
Lic.No.038188
PO. 06/05/19
CHRISTOPHER W. MYERS
CHR

Client

ORR PARTNERS
11180 SUNRISE VALLEY DR
RESTON VIRGINIA 20191

RESTON, VIRGINIA 20191 (703) 289-2100

 Revision / Issue

 No.
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 1.
 1ST SUBMISSION
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 06/05/2019

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Date Description

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HUNTER MILL ASSISTED LIVING

SPECIAL EXCEPTION PLAT

Hunter Mill District Fairfax County, Virginia

Drawn By Checked By JE CM

Project No. MISC-2381

Date JUNE 5, 2019

Drawing Title

SITE SECTION

Scale: AS SHOWN

Drawing Number

10A

ASSIGNMENT - ROOF)

PARKING HOUSE
(2 LEVELS W)
(356)

PARKING (LEVEL + ROOF)

1-350

PARKING - ADRIVE
(A DRIVE - ROOF)

SITE SECTION
SCALE: 1"=30'

# MINIMUM STORMWATER INFORMATION FOR REZONING, SPECIAL EXCEPTION, SPECIAL PERMIT AND DEVELOPMENT PLAN APPLICATIONS

The following information is required to be shown or provided in all zoning applications, or a waiver request of the submission requirement with justification shall be attached. Note: Waivers will be acted upon separately. Failure to adequately address the required submission information may result in a delay in processing this application.

This information is required under the following Zoning Ordinance Sections:

Special Permits (Sect. 8-011 2J & 2L)

Special Exceptions (Sect. 9-011 2J & 2L)

Cluster Subdivision (Sect. 9-615 1G & 1N)

Commercial Revitalization Districts (Sect. 9-622 2A (12) & (14))

Development Plans PRC District (Sect. 16-302 3 & 4L) PRC Plan (Sect. 16-303 1E & 1 O)

FDP P Districts (Sect. 16-502 1A (6) & (17))

Amendments (Sect. 18-202 10F & 10I)

☑ 1. Plat is at a minimum scale of 1"=50' (Unless it is depicted on one sheet with a minimum scale of 1"=100')

A graphic depicting the stormwater management facility(ies) and limits of clearing and grading accommodate the stormwater management facility(ies), storm drainage pipe systems and outlet protection, pond spillways, access roads, site outfalls, energy dissipation devices, and stream stabilization measures as shown on Sheet(s) 7.11 ______.
If infiltration is proposed the soils should be tested for suitability prior to submission of the development plan and results of the infiltration test provided as part of the description of the facility.

# ☑ 3. Provide:

Facility Name/ Type & No. (E.g. dry pond, inflitration trench, underground vault, etc)	On-site area served (acres)	Off-site area served (acres)	Drainage area (acres)	Footprint area (sf)	Storage volume (cf)	If pond, dam height (ft.)
Underground Detention	±4.10	N/A	±4.10	±7,500	±30,000	N/A
				,		
				,		
Totals:						

☑ 4. Onsite drainage channels, outfalls and pipe systems are shown on Sheet(s) 7,11

_____. Pond inlet and outlet pipe systems are shown on Sheet(s) N/A

_____.

Maintenance access (road) to stormwater management facility(ies) are shown on Sheet(s) N/A - Access MH.
Type of maintenance access road surface noted on the plat is N/A - Access MH.
(asphalt, geoblock, gravel, etc.)

8. A description of existing conditions of each numbered site outfall extended downstream from the site to a point which is at least 100 times the site area or which has a drainage area of at least one square mile (640 acres) is provided on Sheet(s) 11-14 If the outfall is proposed to be improved off-site it should be specifically noted.

☑ 9. A detailed description and analysis of how the channel protection requirements and flood protection requirements of each numbered outfall will be satisfied per Stormwater Management Ordinance and Public Facilities Manual are provided on Sheet(s) 14


_____.

■ 10. Existing topography with maximum contour intervals of two (2) feet and a note as to whether it is an air survey or field run is provided on Sheet(s) 5

■ 11. A submission waiver is required for N/A

■ 12. Stormwater management is not required because N/A

14 Revised: 8/4/2015

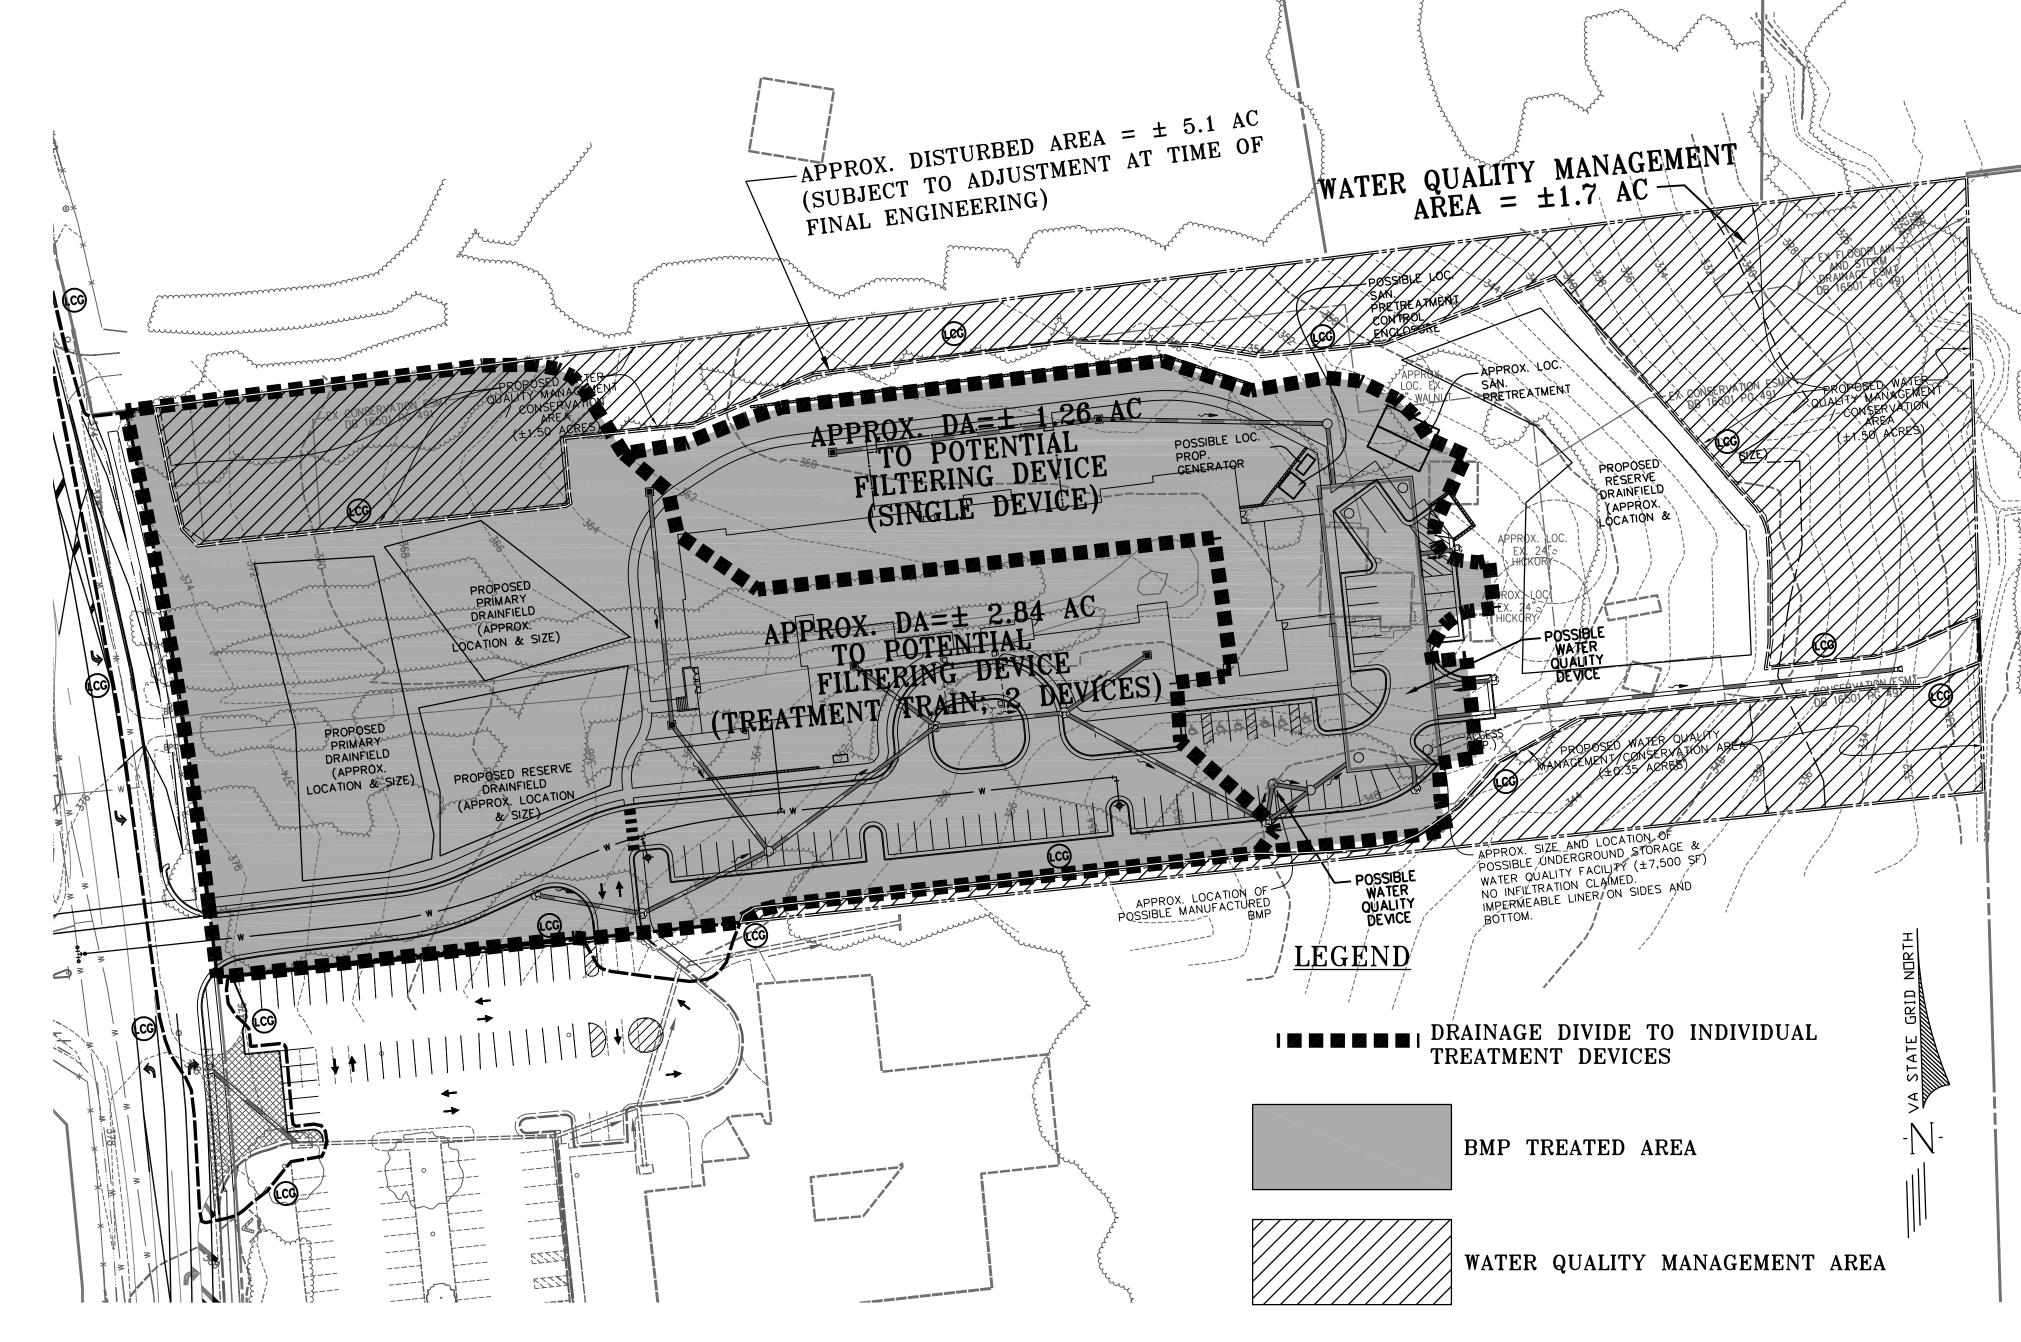

# PRELIMINARY BMP NARRATIVE

WATER QUALITY REQUIREMENTS FOR THE SITE MAY BE MET THROUGH THE USE OF PRESERVATION OF OPEN SPACE AND/OR FILTERING DEVICES IN ACCORDANCE WITH CODE SECTION 124-4-3. THE FACILITIES THAT ARE ULTIMATELY UTILIZED ON THIS SITE SHALL BE IN COMPLIANCE WITH SECTION 9VAC25-870-65 OF THE VIRGINIA STATE CODE FOR WATER QUALITY AND THE LATEST VERSION OF THE FAIRFAX COUNTY PFM.

PER SECTION 124-4-3.A OF THE COUNTY CODE, THE PRELIMINARY BMP COMPUTATIONS FOR THE SUBJECT SITE WERE COMPLETED USING THE LATEST DEQ VIRGINIA RUNOFF REDUCTION METHOD (VRRM) SPREADSHEET. THE COMPUTATIONS SHOW THE TOTAL PHOSPHORUS LOAD REDUCTION REQUIRED FOR THIS SITE DEVELOPMENT IN LBS PER YEAR WITH THE CONSIDERATION OF THE POTENTIAL BMP FACILITIES SHOWN ON THIS APPLICATION; THE COMPUTATIONS CAN BE FOUND ON SHEET 12.

THE POTENTIAL BMP AND SWM FACILITIES AND AREAS SHOWN WITH THIS APPLICATION ARE FOR CONCEPTUAL PURPOSES ONLY. FINAL COMPUTATIONS, SWM AND BMP FACILITY LOCATIONS, AND TYPES OF FACILITIES TO UTILIZED ARE SUBJECT TO CHANGE DURING FINAL ENGINEERING.

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6. 4TH SUBMISSION 06/05/20

04/19/2019

3RD SUBMISSION

te Description

Project Name

HUNTER MILL ASSISTED LIVING

SPECIAL EXCEPTION PLAT

Hunter Mill District Fairfax County, Virginia

Drawn By Checked By CM

Project No. MISC-2381

Date JUNE 5, 2019

Drawing Title

PRELIMINARY BMP ANALYSIS

Scale: 1"=50'

Drawing Number

11

Sheet 11 of 15

# PRELIMINARY BMP CALCULATIONS NOTE:

THE CALCULATION SHOWN ON THIS SHEET REFLECT PRELIMINARY ENGINEERING BASED ON THE 2013 VRRM SPREADSHEET. CALCULATIONS ARE SUBJECT TO BE CHANGED WITH FINAL ENGINEERING.

# Site Results (Water Quality Compliance)

Area Checks	D.A. A	D.A. B	D.A. C	D.A. D	D.A. E	AREA CHECK
Area checks	D.A. A	D.A. D	D.A. C	D.A. D	D.A. L	ANLA CILCK
FOREST/OPEN SPACE (ac)	1.70	0.00	0.00	0.00	0.00	OK.
IMPERVIOUS COVER (ac)	1.68	0.00	0.00	0.00	0.00	OK.
IMPERVIOUS COVER TREATED (ac)	1.68	0.00	0.00	0.00	0.00	OK.
MANAGED TURF AREA (ac)	3.31	0.00	0.00	0.00	0.00	OK.
MANAGED TURF AREA TREATED (ac)	2.25	0.00	0.00	0.00	0.00	OK.
AREA CHECK	OK.	OK.	OK.	OK.	OK.	

Site Treatment Volume (ft³) 8,620

# Runoff Reduction Volume and TP By Drainage Area

por	D.A. A	D.A. B	D.A. C	D.A. D	D.A. E	TOTAL
RUNOFF REDUCTION VOLUME ACHIEVED (ft ³ )	0	0	0	0	0	0
TP LOAD AVAILABLE FOR REMOVAL (lb/yr)	5.25	0.00	0.00	0.00	0.00	5.25
TP LOAD REDUCTION ACHIEVED (lb/yr)	2.78	0.00	0.00	0.00	0.00	2.78
TP LOAD REMAINING (lb/yr)	2.47	0.00	0.00	0.00	0.00	2.47

NITROGEN LOAD REDUCTION ACHIEVED (lb/yr) 0.00 0.00 0.00 0.00 0.00 0.00

### **Total Phosphorus**

5.42	FINAL POST-DEVELOPMENT TP LOAD (lb/yr)
2.67	TP LOAD REDUCTION REQUIRED (lb/yr)
2.78	TP LOAD REDUCTION ACHIEVED (lb/yr)
2.64	TP LOAD REMAINING (lb/yr):
0.00	REMAINING TP LOAD REDUCTION REQUIRED (lb/yr):
2.67 2.78 2.64	TP LOAD REDUCTION REQUIRED (lb/yr) TP LOAD REDUCTION ACHIEVED (lb/yr) TP LOAD REMAINING (lb/yr):

** TARGET TP REDUCTION EXCEEDED BY 0.11 LB/YEAR **

# **Total Nitrogen (For Information Purposes)**

POST-DEVELOPMENT LOAD (lb/yr)	
NITROGEN LOAD REDUCTION ACHIEVED (lb/yr)	
REMAINING POST-DEVELOPMENT NITROGEN LOAD (lb/yr)	38.75

Drainage Area A	A Soils	B Soils	C Soils	D Soils	
Forest/Open Space undisturbed, protected	Area (acres)	0.00	0.53	0.08	1.09
forest/open space or reforested land	CN	30	55	70	77
Managed Turf disturbed, graded for yards or other	Area (acres)	0.00	2.37	0.13	0.81
turf to be mowed/managed	CN	39	61	74	80
Impervious Cover	Area (acres)	0.00	1.28	0.09	0.31
impervious cover	CN	98	98	98	98

Total Area (acres): 6.69 **Runoff Reduction** Volume (ft³): 0

	1-year storm	2-year storm	10-year storm
RV _{Developed} (watershed-inch) with no Runoff Reduction*	0.72	1.07	2.34
RV _{Developed} (watershed-inch) with Runoff Reduction*	0.72	1.07	2.34
Adjusted CN*	75	75	75

**Stormwater Best Management Practices (RR = Runoff Reduction)** 

Stormwater Best Managem	ent Practi	ces (RR =	Runoff Red	duction)								-	Select from dropdown lists-
Practice	Runoff Reduction Credit (%)		Impervious Cover Credit Area (acres)		Runoff Reduction (ft ³ )	Remaining Runoff Volume (ft ³ )	Total BMP Treatment Volume (ft ³ )	Removal Efficiency	Phosphorus Load from Upstream Practices (Ib)	Phosphorus Load to	Practice (lb)		Downstream Practice to be Employed
14. Manufactured Treatment Devices (	no RR)												
14.a. Manufactured Treatment Device- Filtering	0	1.68	0.99	0	0	4,713	4,713	50	0.00	2.96	1.48	1.48	14.b. MTD - Filtering
14.b. Manufactured Treatment Device-Filtering	0	0.57	0.69	4,713	0	7,533	7,533	40	1.48	1.77	1.30	1.95	

		21
TOTAL IMPERVIOUS COVER TREATED (ac)	1.68	AREA CHECK: OK.
TOTAL MANAGED TURF AREA TREATED (ac)	2.25	AREA CHECK: OK.

TOTAL PHOSPHORUS REMOVAL REQUIRED ON SITE (lb/yr) 2.67

TOTAL PHOSPHORUS AVAILABLE FOR REMOVAL IN D.A. A (lb/yr)	5.25
TOTAL PHOSPHORUS REMOVED WITHOUT RUNOFF REDUCTION PRACTICES IN D.A. A (lb/yr)	2.78
TOTAL PHOSPHORUS REMOVED WITH RUNOFF REDUCTION PRACTICES IN D.A. A (lb/yr)	0.00
TOTAL PHOSPHORUS LOAD REDUCTION ACHIEVED IN D.A. A (lb/yr)	2.78
TOTAL PHOSPHORUS REMAINING AFTER APPLYING BMP LOAD REDUCTIONS IN D.A. A (lb/yr)	2.47

# SEE WATER QUALITY COMPLIANCE TAB FOR SITE COMPLIANCE CALCULATIONS

NITROGEN REMOVED WITH RUNOFF REDUCTION PRACTICES IN D.A. A (lb/yr) NITROGEN REMOVED WITHOUT RUNOFF REDUCTION PRACTICES IN D.A. A (lb/yr) TOTAL NITROGEN REMOVED IN D.A. A (lb/yr) 0.00

# Site Land Cover Summary

	A soils	B Soils	C Soils	D Soils	Totals	% of Total
Forest/Open (acres)	0.00	0.53	0.08	1.09	1.70	25
Managed Turf (acres)	0.00	2.37	0.13	0.81	3.31	49
Impervious Cover (acres)	0.00	1.28	0.09	0.31	1.68	25
			_		6.69	100

# Site Tv and Land Cover Nutrient Loads

Site Rv	0.35
Treatment Volume (ft ³ )	8,620
TP Load (lb/yr)	5.42
TN Load (lb/yr)	38.75


**Total TP Load Reduction Required** 2.67

# Site Compliance Summary

Total Runoff Volume Reduction (ft ³ )	0
Total TP Load Reduction Achieved (lb/yr)	2.78
Total TN Load Reduction Achieved (lb/yr)	0.00
Remaining Post Development TP Load (lb/yr)	2.64
Remaining TP Load Reduction (lb/yr)	0.00

** TARGET TP REDUCTION EXCEEDED BY 0.11 LB/YEAR **

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Revision / Issue No. Description 1. 1ST SUBMISSION 10/19/2018

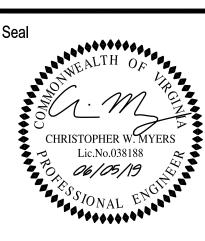1ST SUBMISSION (REV) 11/09/2018 1ST SUBMISSION (REV) 11/20/2018 2ND SUBMISSION 02/25/2019 3RD SUBMISSION 04/19/2019 4TH SUBMISSION 06/05/2019

Project Name

**HUNTER MILL** ASSISTED LIVING

SPECIAL EXCEPTION PLAT

**Hunter Mill District** Fairfax County, Virginia

Checked By

Date JUNE 5, 2019

Project No. MISC-2381

Drawing Title

PRELIMINARY **BMP ANALYSIS** 

Scale: N/A

Drawing Number

# PRELIMINARY SWM NARRATIVE:

THIS APPLICATION IS PROPOSING AN ASSISTED LIVING FACILITY SHOWN ON SHEET 6. AS CURRENTLY SHOWN WITH THIS APPLICATION, THERE IS ONE POINT OF CONCENTRATED DISCHARGE FROM THE DEVELOPED SITE. OUTFALL #1 IS LOCATED TO THE SOUTHEAST OF THE SITE. THE CONCENTRATED FLOW FOR OUTFALL #1 WILL BE DISCHARGED DIRECTLY INTO AN EXISTING NATURAL CHANNEL THAT FLOWS IN A NORTHERN DIRECTION.

UPSTREAM OF OUTFALL #1'S DISCHARGE POINT, A POTENTIAL UNDERGROUND STORMWATER DETENTION FACILITY MAY BE UTILIZED IN ORDER TO REDUCE THE 1-YEAR POST DEVELOPMENT PEAK RUNOFF RATES FROM THE SITE TO BELOW THE PEAK RUNOFF RATES FOR THE SITE USING THE EQUATION REFERENCED IN SECTION 124-4-4.B.3a. THE 2-YEAR AND 10-YEAR POST DEVELOPMENT PEAK RUNOFF RATES FROM THE SITE WILL BE REDUCED PER SECTION 124-4-4.C.4, WHICH STATES THAT IF THE 2-YEAR AND 10-YEAR STORM ARE RELEASED AT A RATE THAT SATISFIES THE EQUATION REFERENCED IN 124-4-4.B.3a, THE DOWNSTREAM REVIEW ANALYSIS SHALL BE LIMITED TO PROVIDING CROSS-SECTIONS TO SHOW A DEFINED CHANNEL. DUE TO THE PROXIMITY OF THE ADJACENT PROPOSED DRAINFIELD, THE POTENTIAL FACILITY IS CURRENTLY SIZED FOR SWM AND BMP ASSUMING NO INFILTRATION AND NO INFILTRATION CREDIT IS CLAIMED.

IN ACCORDANCE WITH PFM SECTION 6-0203.3, THE OUTFALL POINT AT THE NATURAL CHANNEL WILL BE ANALYZED WITH THE RELEASE RATE BASED ON THE CHANNEL PROTECTION AND FLOOD PROTECTION REQUIREMENTS OF CHAPTER 124-4-4 OF THE COUNTY CODE. EXISTING AND PROPOSED DRAINAGE DIVIDES FOR THE OUTFALL POINT HAVE BEEN PROVIDED ON THIS SHEET IN ORDER TO DEMONSTRATE THE PRE AND POST DEVELOPMENT PEAK RUNOFF AREAS. THE DRAINAGE DIVIDES ARE SHOWN BASED ON THE CONCEPTUAL LAYOUT AND ARE SUBJECT TO CHANGE WITH FINAL ENGINEERING.

THERE ARE MULTIPLE AREAS WITHIN THE PROPOSED SITE THAT CONTRIBUTE SHEET FLOW TO OUTFALL #1. PER SECTION 124-4-4.E, THESE SHEET FLOW AREAS DO NOT RESULT IN DOWN-GRADIENT EROSION, SEDIMENTATION, OR FLOODING. IN THE PRE-DEVELOPMENT CONDITION THE ENTIRE 6.69 ACRE SITE CONTRIBUTES SHEET FLOW TO THE NORTH, EAST, AND SOUTH INTO ANGELICO BRANCH. IN THE POST DEVELOPMENT CONDITION APPROXIMATELY 4.10 ACRES OF THE SITE IS DETAINED AND RELEASED AS CONCENTRATED FLOW INTO ANGELICO BRANCH PER SECTION 124-4-4.B3a, AND APPROXIMATELY 2.59 ACRES CONTRIBUTES SHEET FLOW. IN ADDITION TO THE REDUCTION IN SHEET FLOW AREA TO OUTFALL #1 IN THE POST DEVELOPMENT CONDITION, APPROXIMATELY 100% OF THE IMPERVIOUS SITE AREA WILL BE DETAINED IN THE PROPOSED UNDERGROUND DETENTION SYSTEM: THIS ENSURES THAT ONLY TURF AND WOODED AREAS CONTRIBUTE RUNOFF TO OUTFALL #1, SIMILAR TO THE EXISTING CONDITION.

IN ACCORDANCE WITH THE REQUIREMENTS OUTLINED IN SECTION 124-4-4 OF THE COUNTY CODE, THE RELEASE RATE REQUIREMENT WILL BE SATISFIED. ADDITIONAL CALCULATIONS WILL BE INCLUDED WITH THE FINAL SITE PLAN.

# PRELIMINARY SWM NOTE:

AREAS, CALCULATIONS AND FACILITY LOCATIONS SHOWN WITH THIS APPLICATION ARE FOR PRELIMINARY PURPOSES ONLY. THEY ARE SUBJECT TO CHANGE WITH FINAL ENGINEERING.

# "SITE" DEFINITION:

FOR THE PURPOSE OF THIS NARRATIVE, THE SITE IS DEFINED AS THE AREA WITHIN THE PROPERTY BOUNDARY THAT DRAINS TO THE POSSIBLE UNDERGROUND STORMWATER DETENTION FACILITY (APPROXIMATE AREA = 7,500 SF AND APPROXIMATE STORAGE VOLUME = 30,000 CF). ONLY ONSITE DRAINAGE IS CONSIDERED IN THE CALCULATION WHEN DETERMINING THE ALLOWABLE PEAK FLOW RATE OF RUNOFF FROM THE DEVELOPED SITE. PER THE FAIRFAX COUNTY PFM AND THE COUNTY CODE, THIS WILL SATISFY THE RELEASE RATE REQUIREMENTS FOR THE SITE. THE SITE IS APPROXIMATELY 4.10 ACRES ACRES AND CONSISTS OF HYDROLOGIC GROUP B,C AND D SOILS (SEE SHEET 2 OF THE PLANS).

# UNDERGROUND DETENTION SIZING:

THE UNDERGROUND DETENTION SYSTEM WAS PRELIMINARILY SIZED USING BENTLEY POND BACK TO REDUCE PEAK FLOW FOR THE 1, 2 AND 10-YEAR 24 HOUR STORMS PER THE REQUIREMENTS OF EQUATION 124-4-4.B.3c. THE PEAK FLOW VOLUME GENERATED (SEE COMPUTATIONS BELOW FOR POND PACK RESULTS) FOR THE 10-YEAR STORM WAS CALCULATED AS APPROXIMATELY 0.541 AC-FT (APPROXIMATELY 24,000 CUBIC FEET). IN ORDER TO CONSERVATIVELY ROUTE THE 10-YEAR FLOW THROUGH THIS FACILITY WITHOUT OVERTOPPING THE DETENTION SYSTEM, A FACILITY OF APPROXIMATELY 30,000 CUBIC FEET WAS PROPOSED.

THE PROPOSED APPROXIMATE DEPTH OF THIS FACILITY IS 6.75' IN ORDER TO ACHIEVE THIS REQUIRED VOLUME, A FOOTPRINT OF 150' BY 50' WITH AN ASSUMED EFFECTIVE VOID RATIO OF APPROXIMATELY 60% (COMPOSITE OF 100% FOR OPEN CELLS AND 40% STONE BACKFILL, SIMILAR TO STORMTECH SYSTEMS BY ADS) WAS PROPOSED TO FIT WITHIN THE PARKING AREA BETWEEN THE ASSISTED LIVING FACILITY AND OUTFALL LOCATION WITHOUT AFFECTING PROPOSED DRAINFIELDS.

### Catchments Summary

Label	Scenario	Return Event (years)	Hydrograph Volume (ac-ft)	Time to Peak (hours)	Peak Flow (ft³/s)
To Underground Detention	Post-Development 10 -year	10	0.895	12.150	11.36

# **Node Summary**


Label	Scenario	Return Hydrograph Event Volume (years) (ac-ft)		Time to Peak (hours)	Peak Flow (ft³/s)
Outfall #1	Post-Development 10 -year	10	0.533	14.050	0.73

# Pond Summary


Label	Scenario	Return Event (years)	Hydrograph Volume (ac-ft)	Time to Peak (hours)	Peak Flow (ft³/s)	Maximum Water Surface Elevation (ft)	Maximum Pond Storage (ac-ft)	
Underground Detention (IN)	Prost- Dievelopment 10-year	10	0.895	12.150	11.36	(N/A)	(N/A)	
Underground Detention (OUT)	Post- Development 10-year	10	0.533	14.050	0.73	349.17	0.541	- VALUE USED TO DETERMINE FACILITY VOLUME


**LEGEND** 



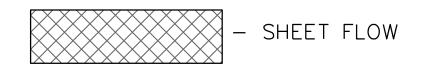

- ON-SITE AREA DRAINING TO OUTFALL #1

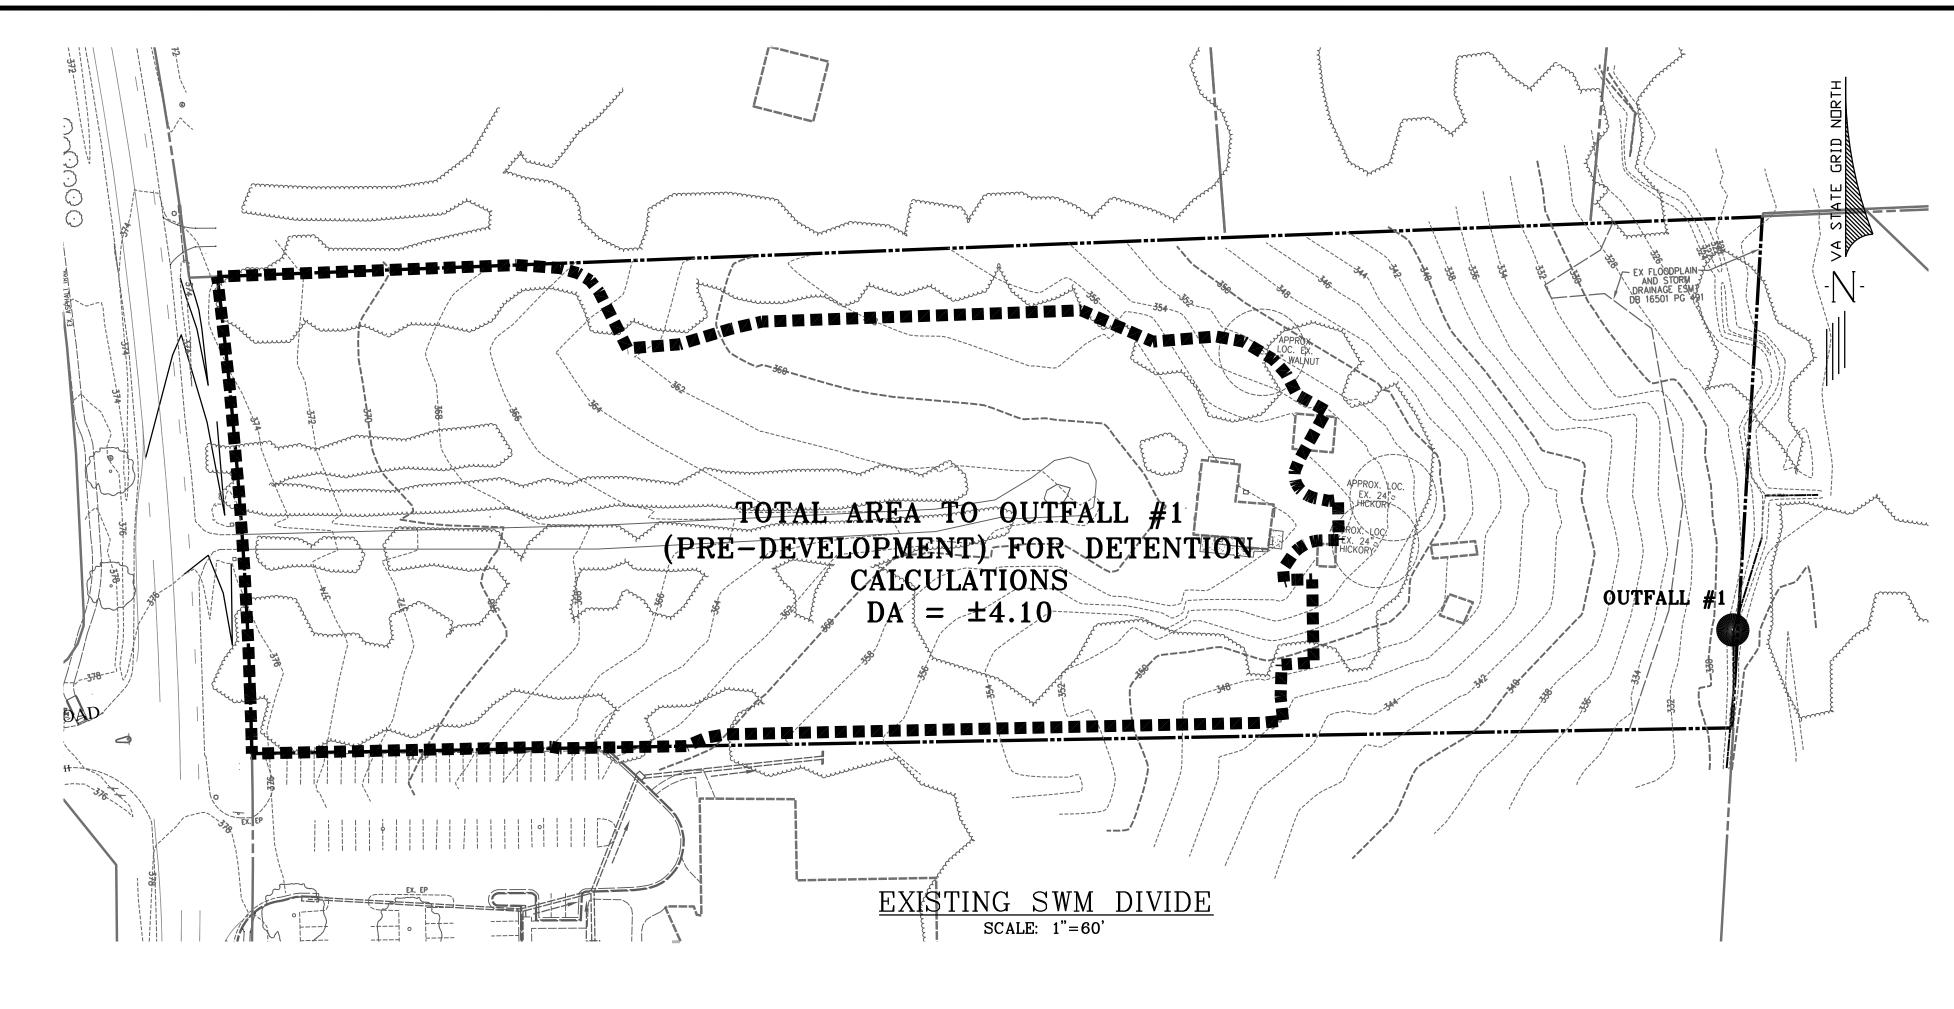

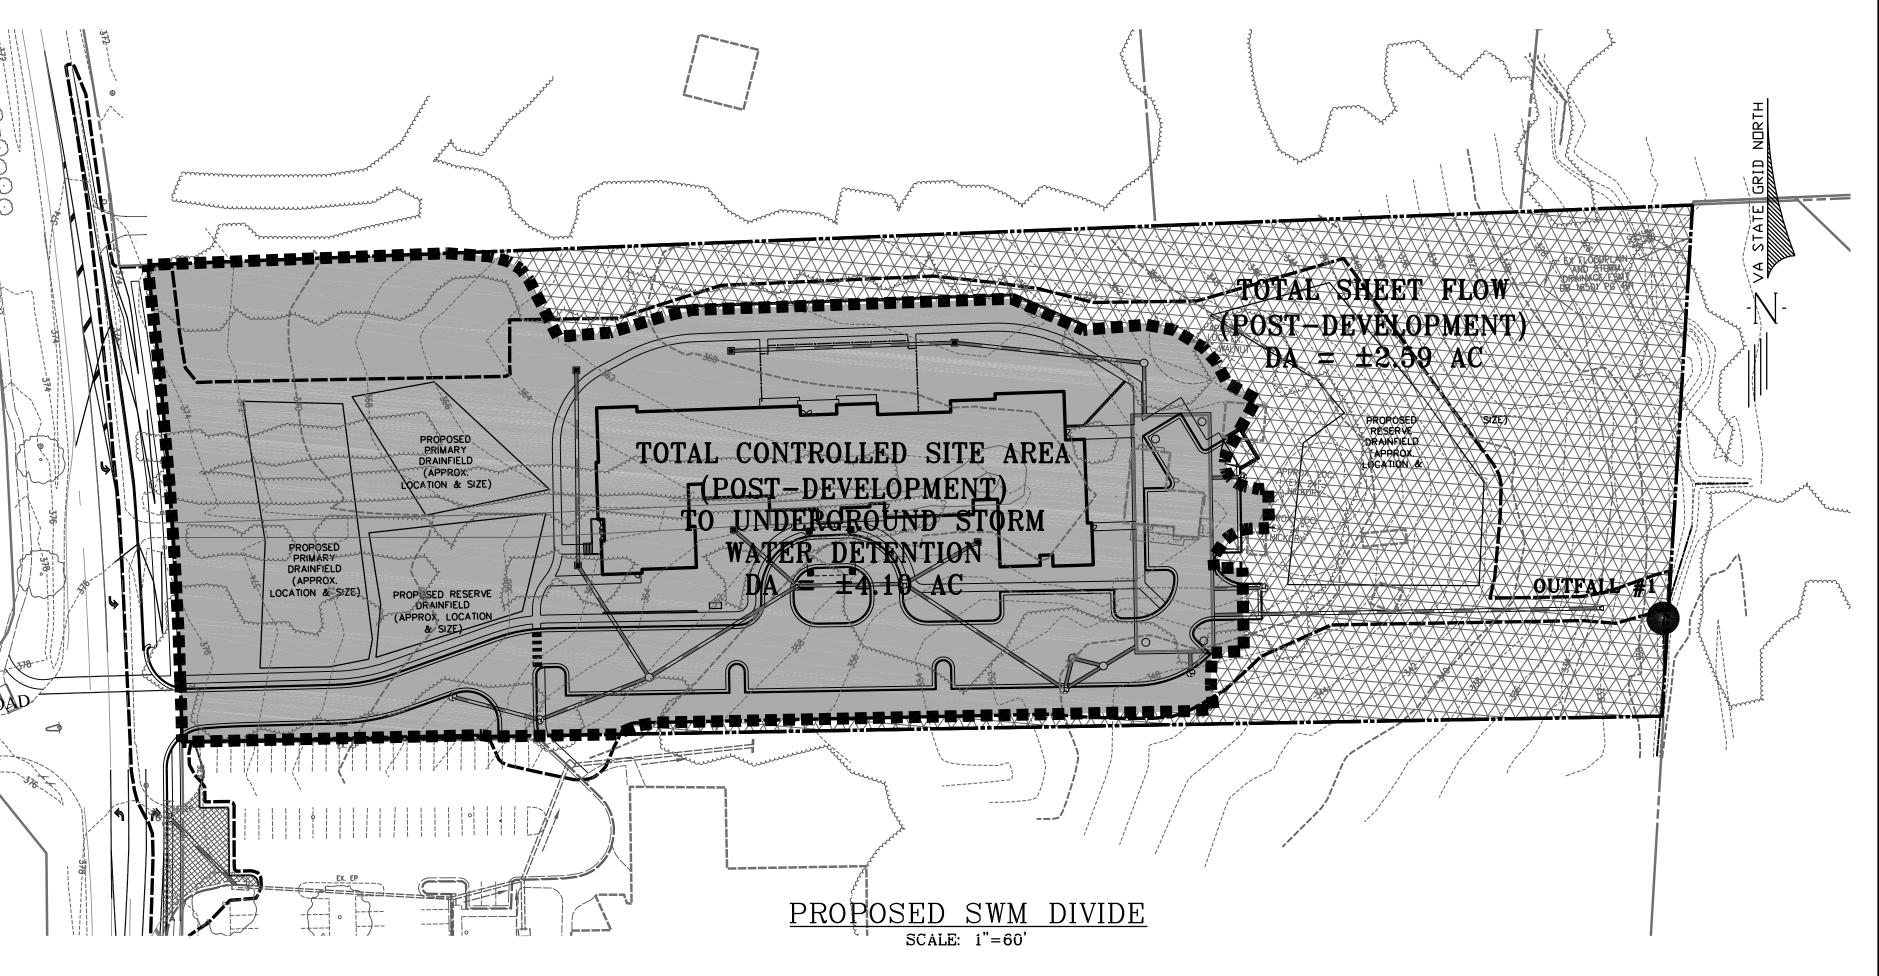

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 Revision / Issue

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 11/20/2018

02/25/2019

04/19/2019

2ND SUBMISSION

3RD SUBMISSION

6. 4TH SUBMISSION 06/05/2019

sue te Description

Project Name

HUNTER MILL ASSISTED LIVING

SPECIAL EXCEPTION PLA

Hunter Mill District
Fairfax County, Virginia

Drawn By

Checked By

Project No. MISC-2381

Date JUNE 5, 2019

Drawing Title

PRELIMINARY SWM ANALYSIS

Scale: 1:60

Drawing Number

GRAPHIC SCALE

( IN FEET )
1 inch = 60 ft.

Sheet 13 of 15

# PRELIMINARY OUTFALL NARRATIVE:

THERE IS ONE POTENTIAL POINT OF CONCENTRATED DISCHARGE FROM THE DEVELOPED SITE. OUTFALL #1 IS LOCATED TO THE SOUTHEAST OF THE SITE. THE CONCENTRATED FLOW FOR OUTFALL #1 WILL BE DISCHARGED DIRECTLY INTO AN EXISTING NATURAL CHANNEL THAT FLOWS IN A NORTHERN DIRECTION. IN ACCORDANCE WITH SECTION 124-4-4 OF THE COUNTY CODE, ONLY CONCENTRATED OUTFALLS HAVE BEEN ANALYZED FOR ADEQUATE CHANNEL AND FLOOD PROTECTION WITH THIS APPLICATION.

# PRELIMINARY OUTFALL ANALYSIS FOR OUTFALL #1:

#### CHANNEL PROTEC

SECTION 124-4-4.B.3 OF THE COUNTY CODE STATES THAT WHEN OUTFALLING INTO A NATURAL STORMWATER CONVEYANCE SYSTEM, THE CHANNEL PROTECTION REQUIREMENT OF ADEQUATE OUTFALL IS SATISFIED BY VERIFYING THAT THE MAXIMUM PEAK FLOW RATE FROM THE 1-YEAR 24-HOUR STORM FOLLOWING THE LAND-DISTURBING ACTIVITIES MEETS THE CRITERIA OF 124-4-4.B.3.a ("DETENTION METHOD").

THIS APPLICATION IS PROPOSING POTENTIAL SWM/BMP FACILITIES, AS DESCRIBED ON SHEET 8, PROPOSED ONSITE AND UPSTREAM OF OUTFALL #1 THAT ARE DESIGNED TO DETAIN THE 1-YEAR STORM PER SECTION 124-4-4.B.3.a. THEREFORE, PER SECTION 124-4-4.B.6.c, THE LIMITS OF ANALYSIS IS LOCATED AT LEAST 150 FEET DOWNSTREAM OF A POINT WHERE THE RECEIVING PIPE OR CHANNEL IS JOINED BY ANOTHER THAT HAS A DRAINAGE AREA THAT IS AT LEAST 90 PERCENT OF THE SIZE OF THE FIRST DRAINAGE AREA AT THE POINT OF CONFLUENCE. THE LIMIT OF ANALYSIS IS LOCATED APPROXIMATELY 150' NORTH OF OUTFALL#1 WITHIN A NATURAL CHANNEL IN ANGELICO BRANCH. THE CONTRIBUTING DRAINAGE AREA FROM THE SITE IS APPROXIMATELY 4.10 ACRES, AND THE OFF SITE CONTRIBUTING DRAINAGE AREA TO THE CONFLUENCE POINT IS APPROXIMATELY 82 ACRES; THEREFORE, THE 90 PERCENT REQUIREMENT HAS BEEN MET. WITH THE USE OF THE DETENTION METHOD AND THE ANALYSIS DESCRIBED ABOVE, THE CHANNEL PROTECTION CRITERIA PER SECTION 124-4-4.B FOR OUTFALL #1 WILL BE SATISFIED WITH THE FINAL SITE PLAN.

### FLOOD PROTECTION:

SECTION 124-4-4.C.4 OF THE COUNTY CODE STATES THAT IF THE DETENTION REQUIREMENTS OF SECTION 124-4-8.3a ARE MET FOR THE 2-YEAR AND 10-YEAR 24 HOUR STORMS, THE DOWNSTREAM ANALYSIS SHALL BE LIMITED TO PROVIDING CROSS SECTIONS TO DEMONSTRATE A DEFINED CHANNEL EXISTS AND CHECKING FOR FLOODING OF EXISTING DWELLINGS OR BUILDINGS CONSTRUCTED UNDER AN APPROVED BUILDING PERMIT FROM THE 100-YEAR STORM EVENT FOR THE EXTENT OF REVIEW. THE EXTENT OF REVIEW SHALL BE LIMITED TO A POINT WHERE THE RECEIVING PIPE OR CHANNEL IS JOINED BY ANOTHER THAT HAS A DRAINAGE AREA THAT IS AT LEAST 90 PERCENT OF THE SIZE OF THE FIRST DRAINAGE AREA AT THE POINT OF CONFLUENCE. THE LIMIT OF THIS ANALYSIS IS LOCATED APPROXIMATELY 150' NORTH OF OUTFALL #1 WITHIN A NATURAL CHANNEL IN ANGELICO BRANCH. THE CONTRIBUTING DRAINAGE AREA FROM THE SITE IS APPROXIMATELY 4.10 ACRES, AND THE OFF SITE CONTRIBUTING DRAINAGE AREA TO THE CONFLUENCE POINT IS APPROXIMATELY 82 ACRES; THEREFORE, THE 90 PERCENT REQUIREMENT HAS BEEN MET. WITH THE USE OF THE DETENTION METHOD AND THE ANALYSIS DESCRIBED ABOVE, THE FLOOD PROTECTION CRITERIA PER SECTION 124-4-4.C FOR OUTFALL #1 WILL BE SATISFIED WITH THE FINAL SITE PLAN.

# SHEET FLOW NARRATIVE:


THERE ARE MULTIPLE AREAS WITHIN THE PROPOSED SITE THAT CONTRIBUTE SHEET FLOW TO OUTFALL #1. PER SECTION 124-4-4.E, THESE SHEET FLOW AREAS DO NOT RESULT IN DOWN-GRADIENT EROSION, SEDIMENTATION, OR FLOODING. IN THE POST-DEVELOPMENT CONDITION, THE CONTRIBUTING AREA OF SHEET FLOW TO OUTFALL #1 HAS BEEN DECREASED SIGNIFICANTLY WHEN COMPARED TO PRE-DEVELOPMENT, AND WILL GENERALLY FOLLOW THE SAME SLOPE AND DIRECTION AS THE PRE-DEVELOPMENT AREAS. IN THE PRE-DEVELOPMENT CONDITION THE ENTIRE 6.69 ACRE SITE CONTRIBUTES SHEET FLOW TO THE NORTH, EAST, AND SOUTH INTO ANGELICO BRANCH. IN THE POST DEVELOPMENT CONDITION APPROXIMATELY 4.10 ACRES OF THE SITE IS DETAINED AND RELEASED AS CONCENTRATED FLOW INTO ANGELICO BRANCH PER SECTION 124-4-4.B3a, AND APPROXIMATELY 2.59 ACRES CONTRIBUTES SHEET FLOW.

# PRELIMINARY OUTFALL NOTE:

OUTFALL LOCATIONS, DRAINAGE AREAS AND FACILITY LOCATIONS ARE SHOWN CONCEPTUALLY WITH THIS APPLICATION. THE ADEQUATE OUTFALL ANALYSIS, SITE LAYOUT AND CALCULATIONS SHOWN WITH THIS APPLICATION ARE FOR PRELIMINARY PURPOSES ONLY. THEY ARE ALL SUBJECT TO CHANGE WITH FINAL ENGINEERING.

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 02/25/2019

 5.
 3RD SUBMISSION
 04/19/2019

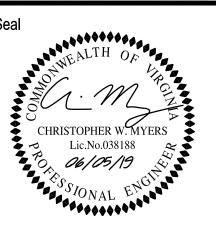06/05/2019

Issue

4TH SUBMISSION

Project Name

HUNTER MILL
ASSISTED LIVING

SPECIAL EXCEPTION PLAT

Hunter Mill District Fairfax County, Virginia

Drawn By Checked By JE CM

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Project No. MISC-2381

Date JUNE 5, 2019

Drawing Title

ADEQUATE OUTFALL ANALYSIS

Scale: 1" = 200'

Drawing Number

**14**Sheet 14 of 15

MSC-2381

**LEGEND** 

DRAINAGE DIVIDE

GRAPHIC SCALE

